
Commercial Development 431 Macquarie Street, Liverpool NSW 2170

Landscape Development Application

DRAWINGS

DWG NO.	DRAWING TITLE	SCALE
000	COVER SHEET	
100	LANDSCAPE COMPOSITE PLAN	1:200
C101.1 101.1 102.1 103.1 104.1 105 201.1 202	LANDSCAPE PLAN - GROUND FLOOR (RENDER) LANDSCAPE PLAN - GROUND FLOOR LANDSCAPE DETAIL PLAN - GROUND FLOOR LANDSCAPE DETAIL PLAN - GROUND FLOOR LANDSCAPE DETAIL PLAN - GROUND FLOOR LANDSCAPE PLAN - LEVEL 4 LANDSCAPE PLANTING PLAN - GROUND FLOOR LANDSCAPE PLANTING PLAN - LEVEL 4	1:200 1:200 1:100 1:100 1:100 1:200 1:150
500 501	LANDSCAPE SPECIFICATION NOTES LANDSCAPE DETAILS	AS SHOWN
C101.2 101.2 102.2 103.2 104.2	LANDSCAPE PLAN - (Future) GROUND FLOOR (RENDER) LANDSCAPE PLAN - (Future) GROUND FLOOR LANDSCAPE DETAIL PLAN - (Future) GROUND FLOOR LANDSCAPE DETAIL PLAN - (Future) GROUND FLOOR LANDSCAPE DETAIL PLAN - (Future) GROUND FLOOR	1:200 1:200 1:100 1:100 1:100
201.2	LANDSCAPE PLANTING PLAN - (Future) GROUND FLOOR	

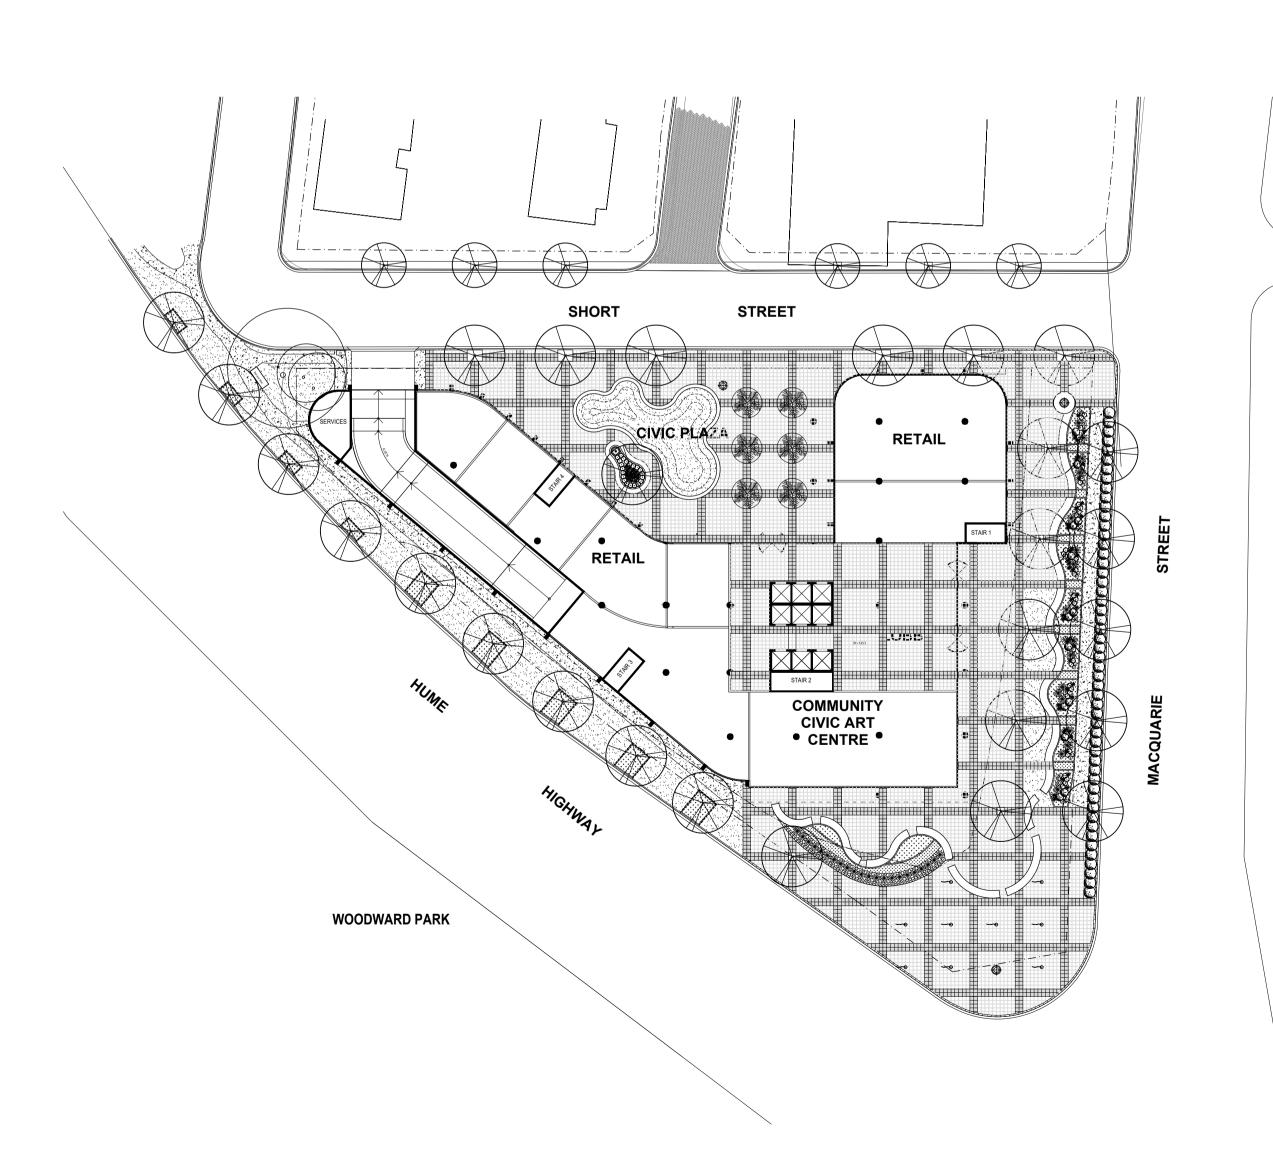

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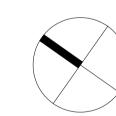
Development Application PH RS 30.
Development Application PH RS 09.
Development Application PH RS 27.
Development Application PH RS 24.

Development Application
Development Application
Development Application
Revision Description

PH RS 09.03.2020
PH RS 27.02.2020
PH RS 24.02.2020
NPE RS 28.02.2019
PH RS 08.02.2019
Drawn Check Date

LEGEND

Key Pla



BINAH DEVELOPMENTS

Architect

MOSCA PSERRAS ARCHITECTS

431 MACQUARIE STREET LIVERPOOL

SITE IMAGE

Level 1, 3-5 Baptist Street Redfern NSW 2016 Australia


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Development Application

Coversheet



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F Development Application E Development Application

PH RS 30.08.2020

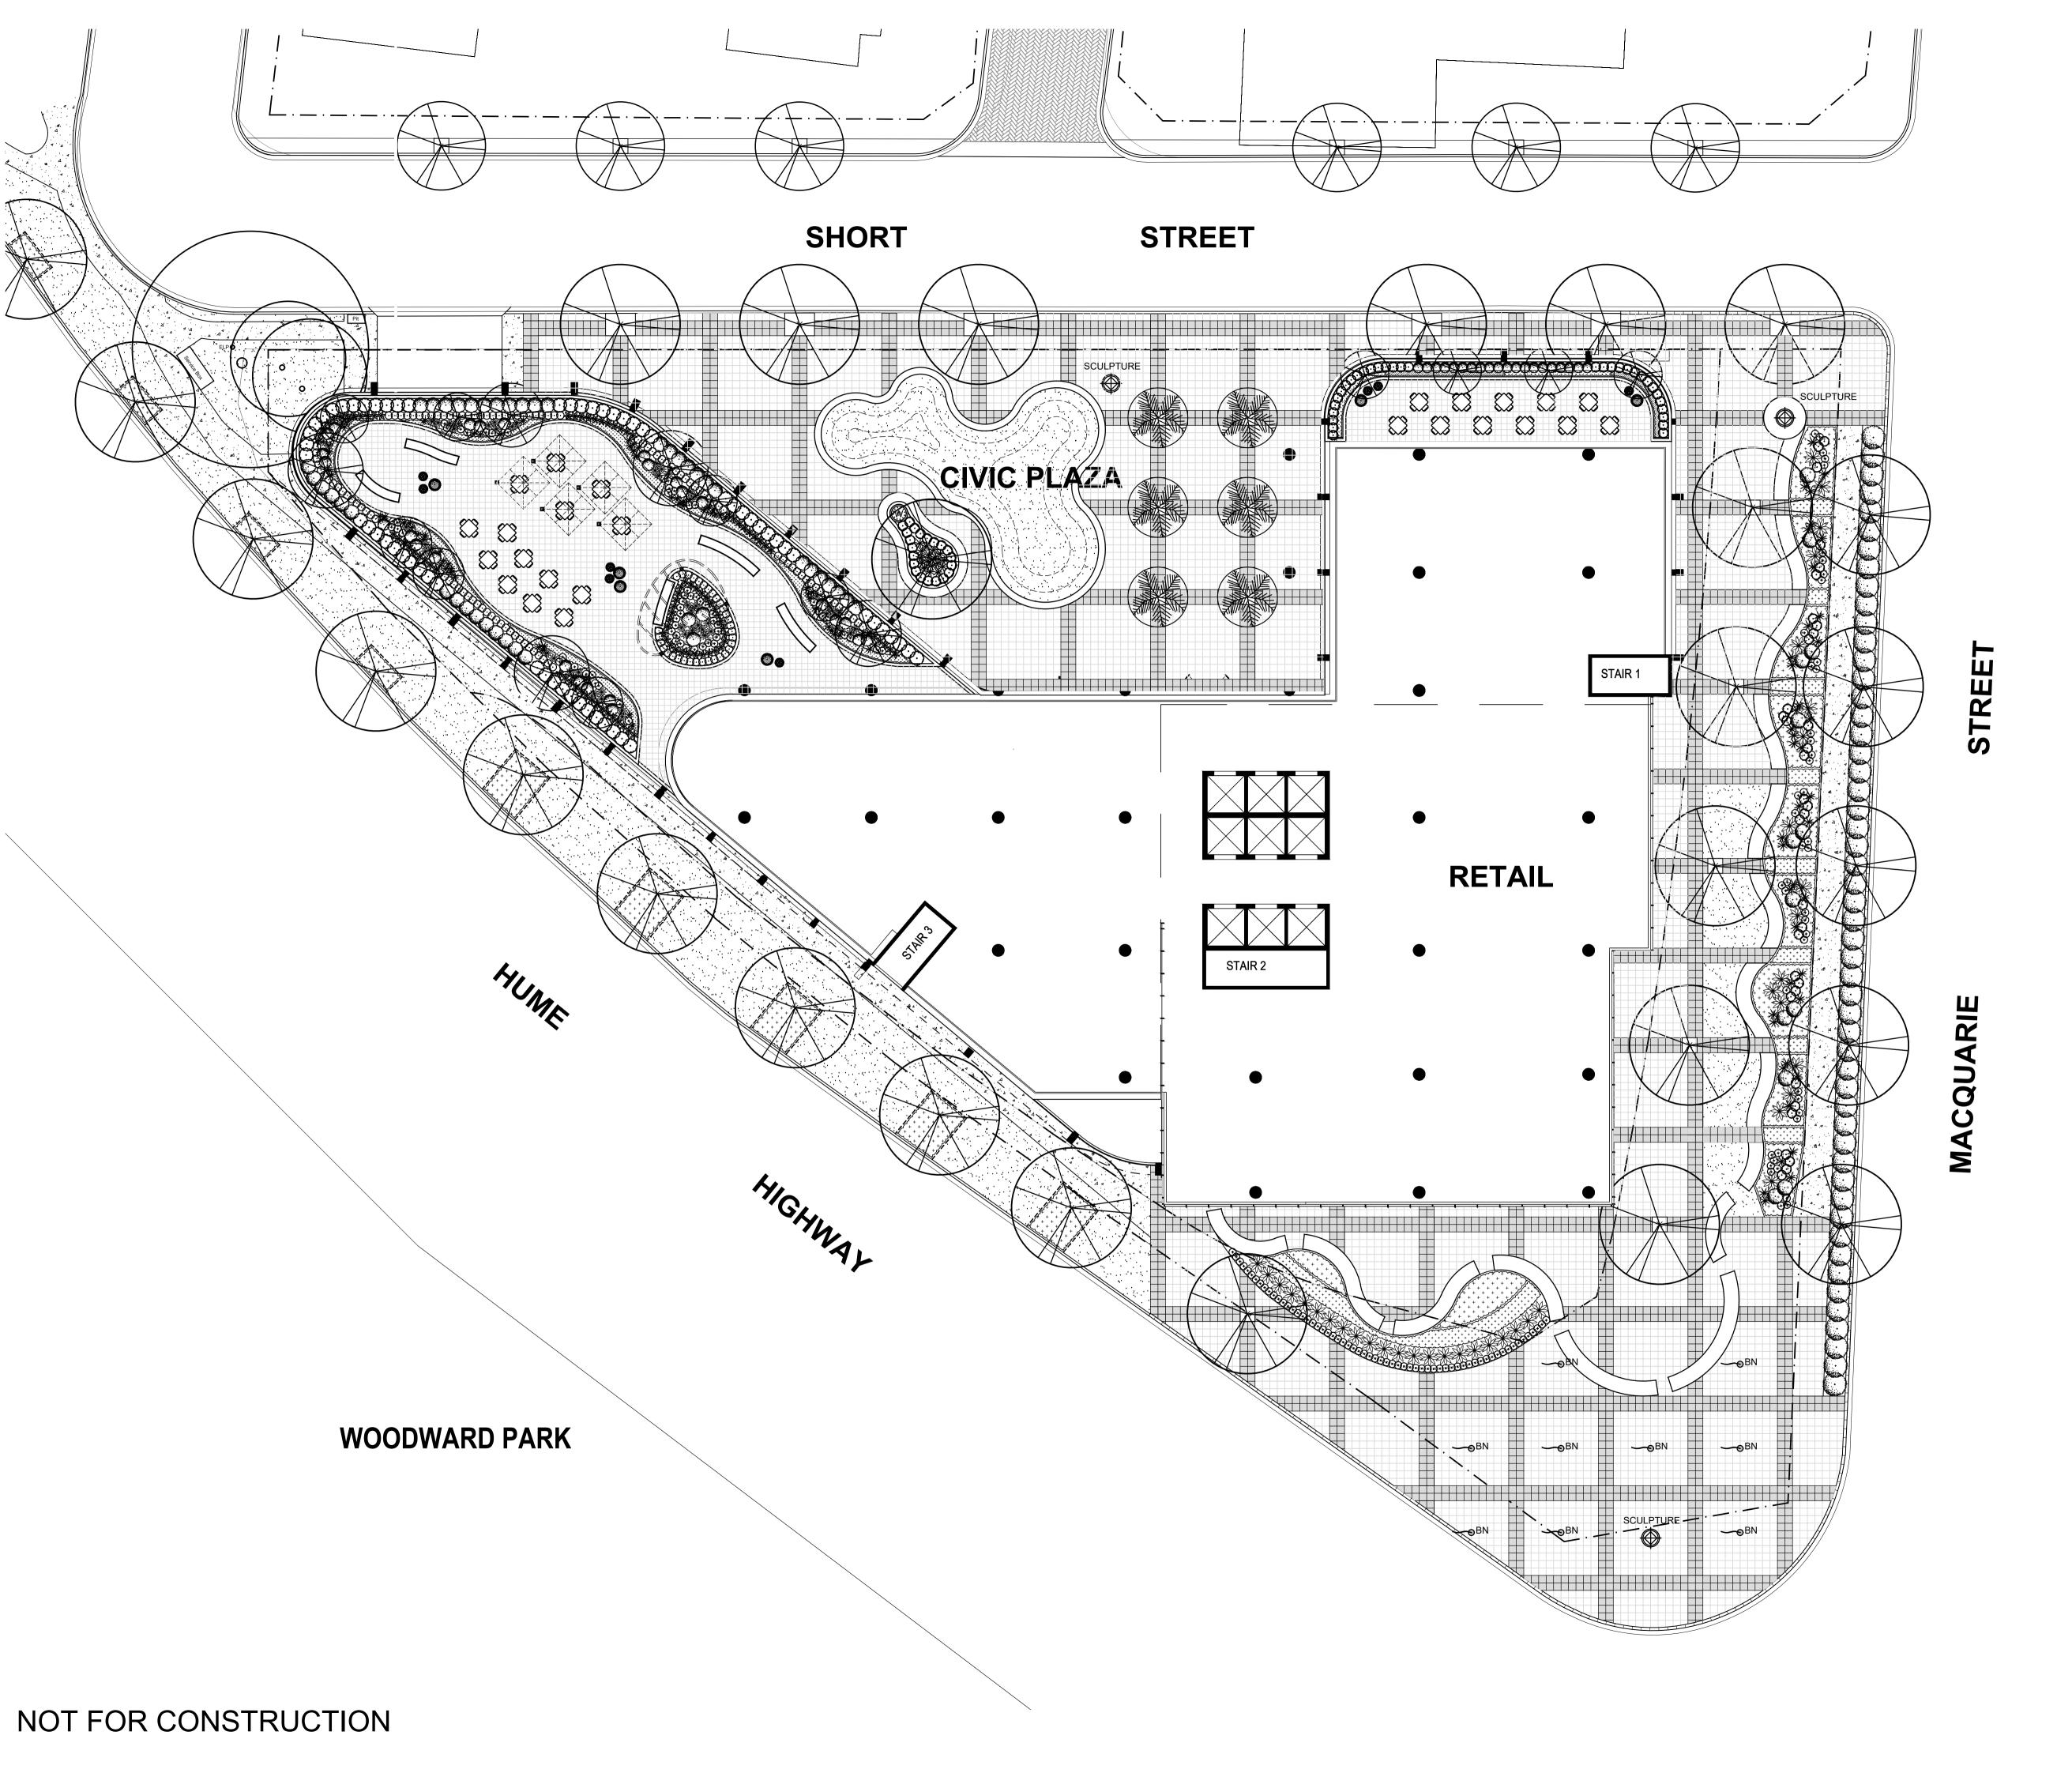Development Application Development Application B Development Application A Development Application Issue Revision Description

PH RS 09.03.2020 PH RS 27.02.2020 PH RS 24.02.2020 NPE RS 28.02.2019 PH RS 08.02.2019 Drawn Check Date

LEGEND

Proposed palm

Proposed tree

Proposed turf area

Proposed plaza paving with banding

Proposed Gutter & Bluestone Kerb

Proposed Bench Seating,
Table & Chairs

Proposed Sculpture



BN Proposed Flag Banner

BINAH DEVELOPMENTS

MOSCA PSERRAS ARCHITECTS

431 MACQUARIE STREET LIVERPOOL

SITE IMAGE

Level 1, 3-5 Baptist Street Redfern NSW 2016 Australia

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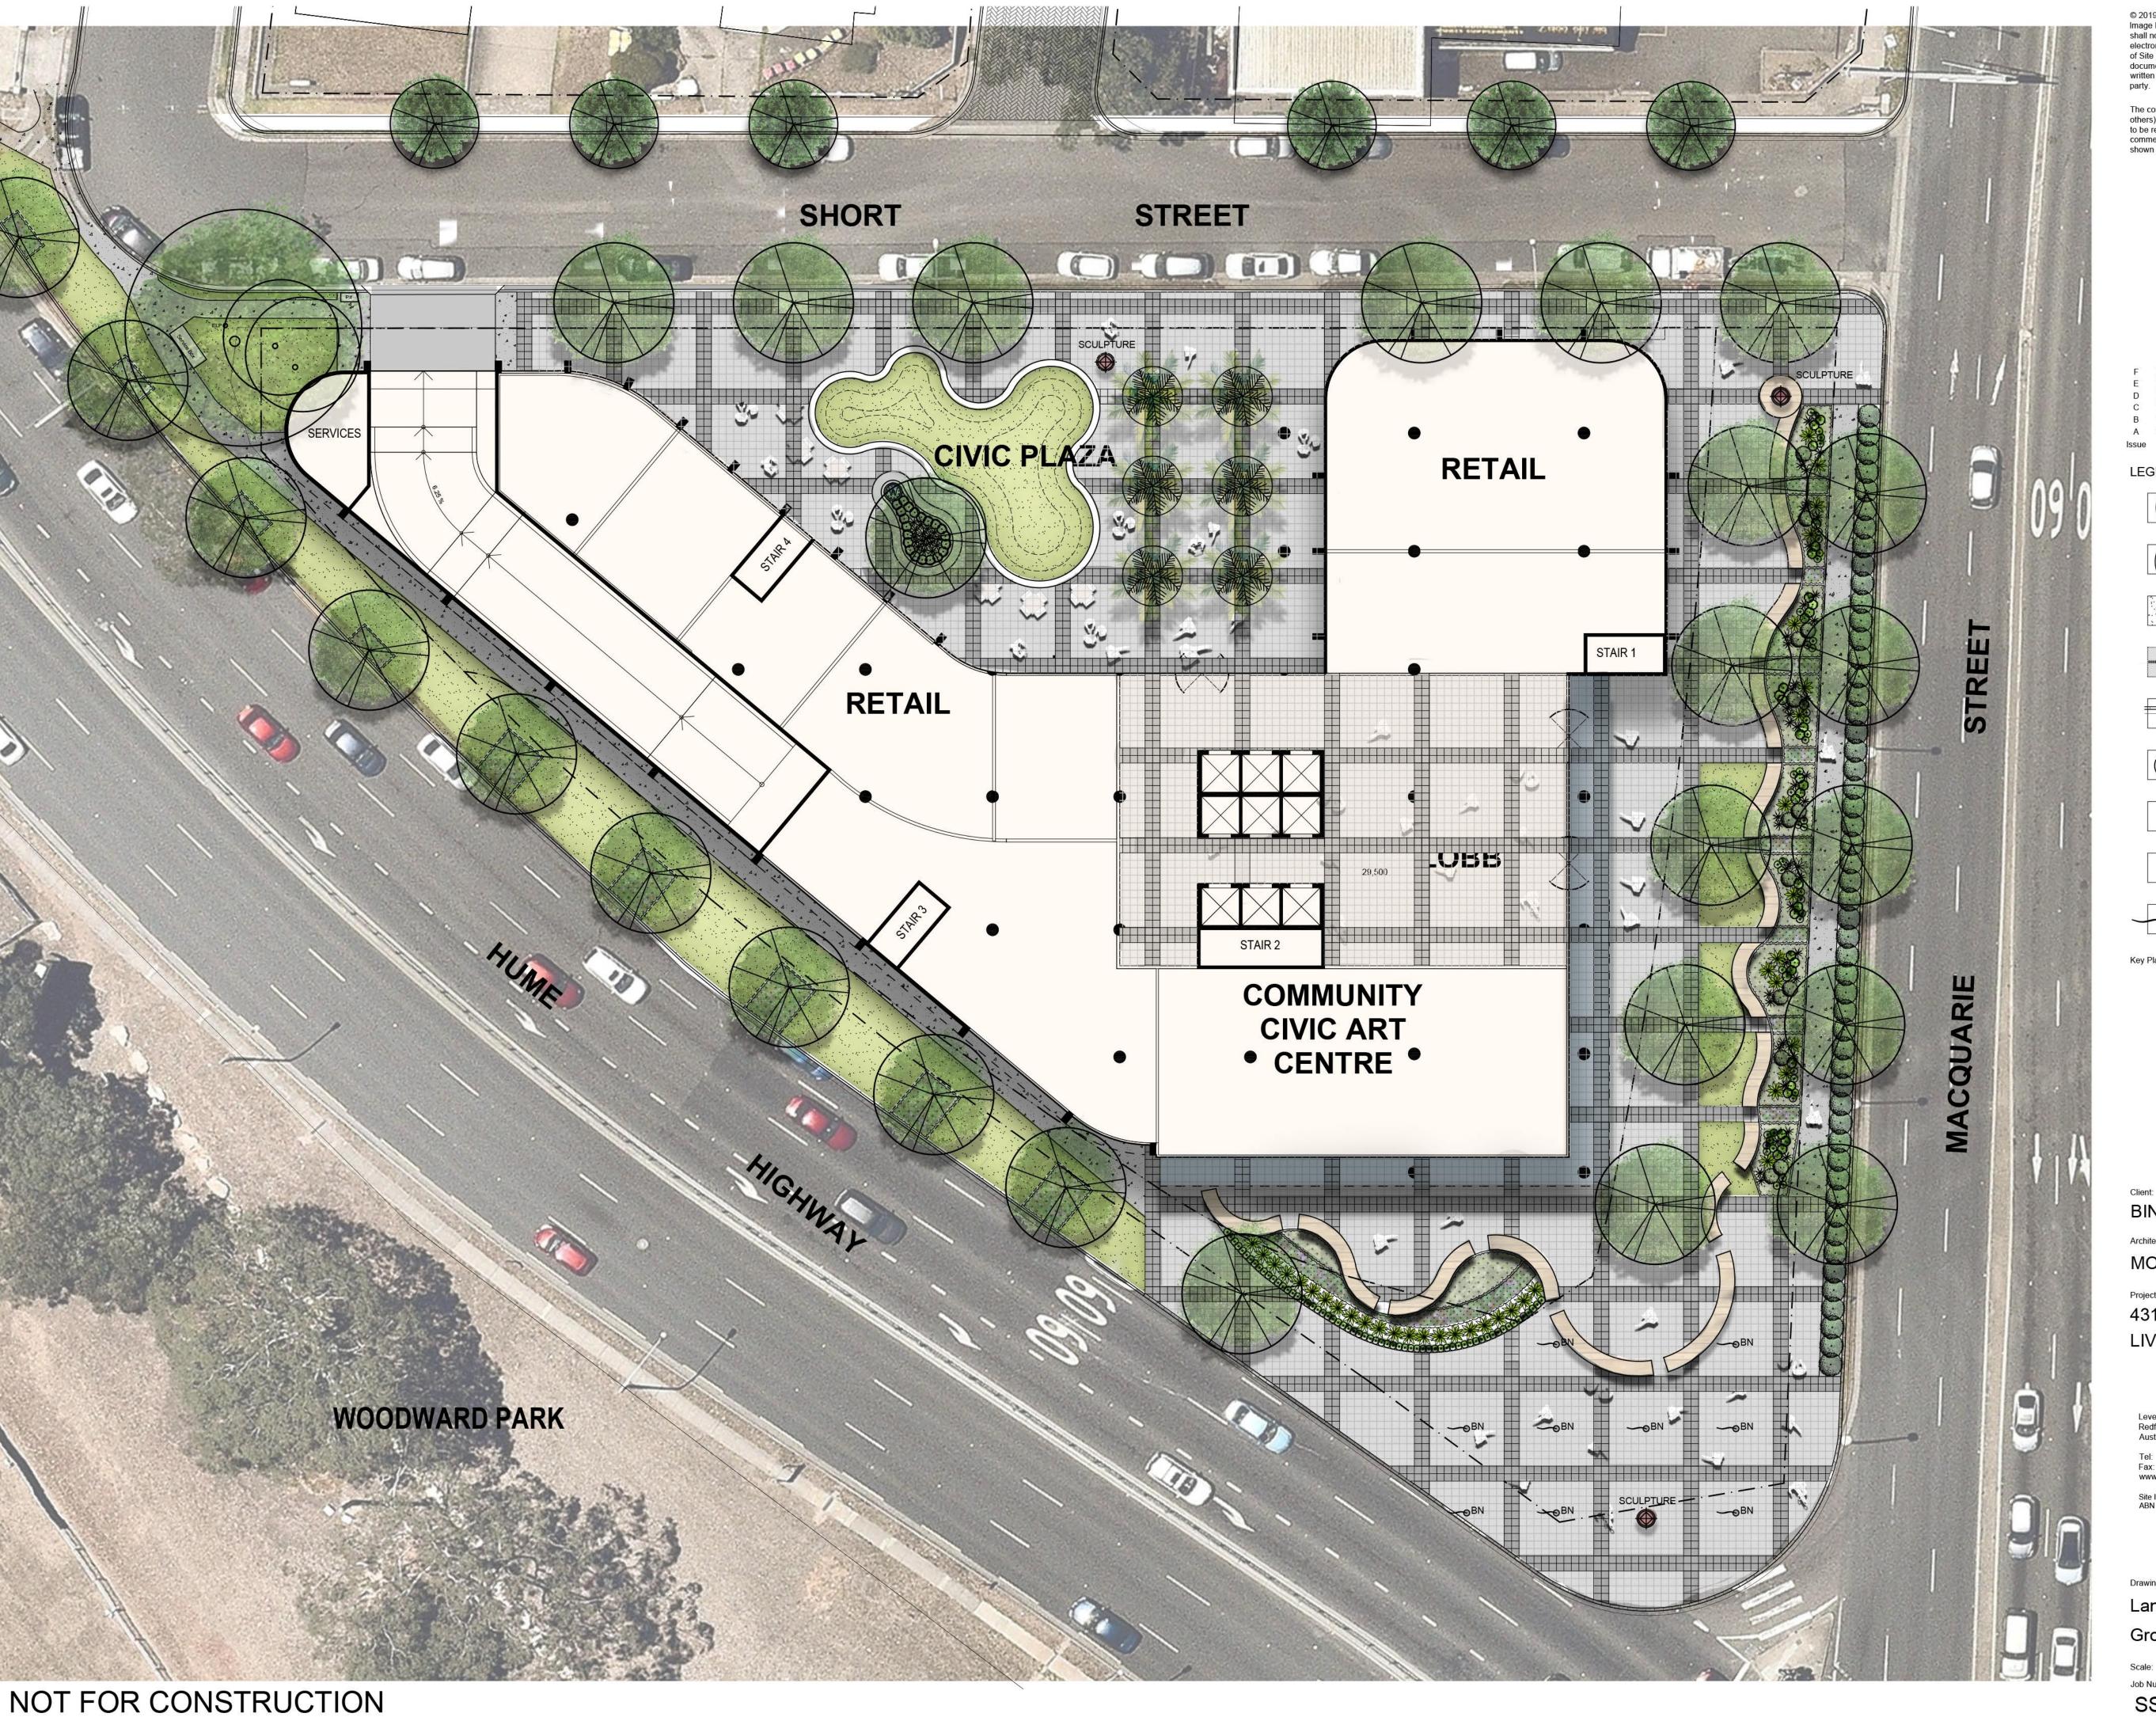
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Landscape Architects

Development Application

Landscape Plan - Composite

SS17-3689 100 F



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Development Application Development Application Development Application **Development Application** B Development Application

A Development Application Issue Revision Description

LEGEND

Proposed tree

Proposed turf area

Proposed plaza paving with banding

Proposed Gutter & Bluestone Kerb

Proposed Bench Seating, Table & Chairs

Proposed Sculpture

Water Feature

BINAH DEVELOPMENTS

MOSCA PSERRAS ARCHITECTS

431 MACQUARIE STREET LIVERPOOL

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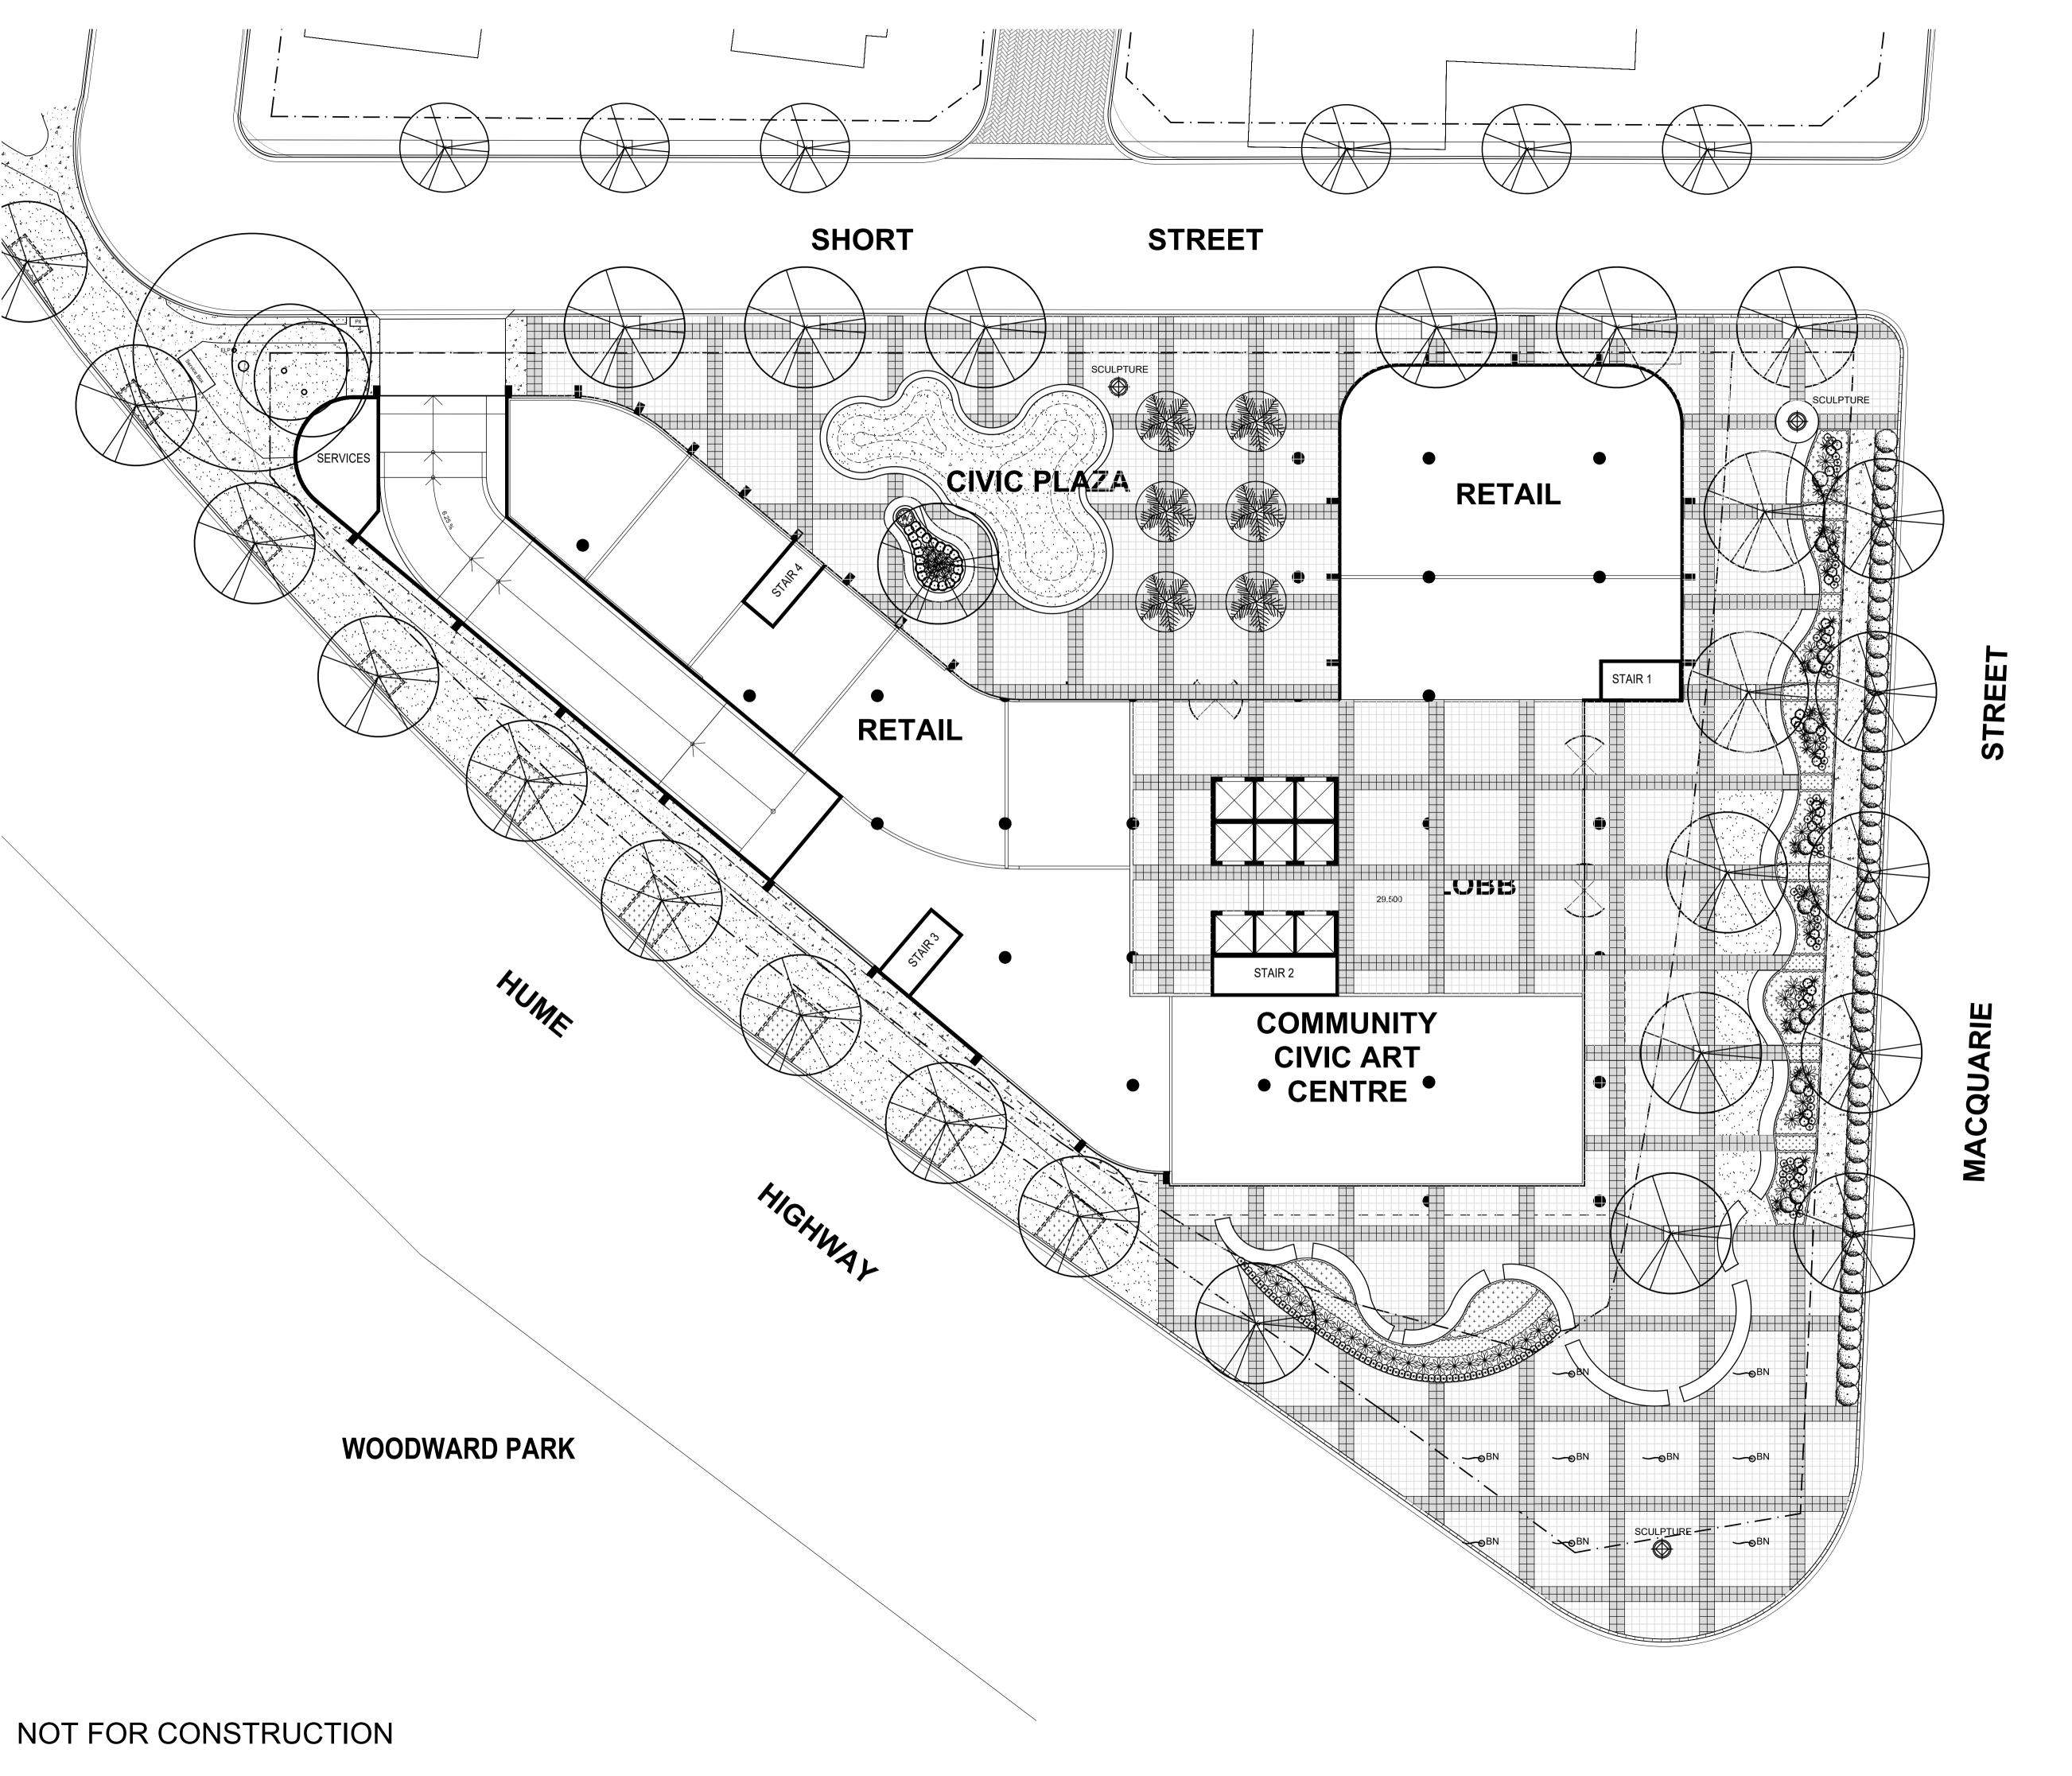
Development Application

Landscape Plan

Ground Floor (Render) Scale: 1:200 @ A1 0 1 2

C101.1 F

SS17-3689



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Development Application Development Application PH RS 24.02.2020 Development Application NPE RS 28.02.2019 Development Application A Development Application PH RS 08.02.2019

Drawn Check Date

LEGEND

Proposed tree planting

Issue Revision Description

Proposed palm

turf area

Proposed plaza paving with banding

Proposed Gutter & Bluestone Kerb

Proposed Bench Seating,

Proposed Sculpture

Proposed
Water Feature

BN Proposed Flag Banner

BINAH DEVELOPMENTS

MOSCA PSERRAS ARCHITECTS

431 MACQUARIE STREET LIVERPOOL

SITE IMAGE

Level 1, 3-5 Baptist Street Redfern NSW 2016 Australia

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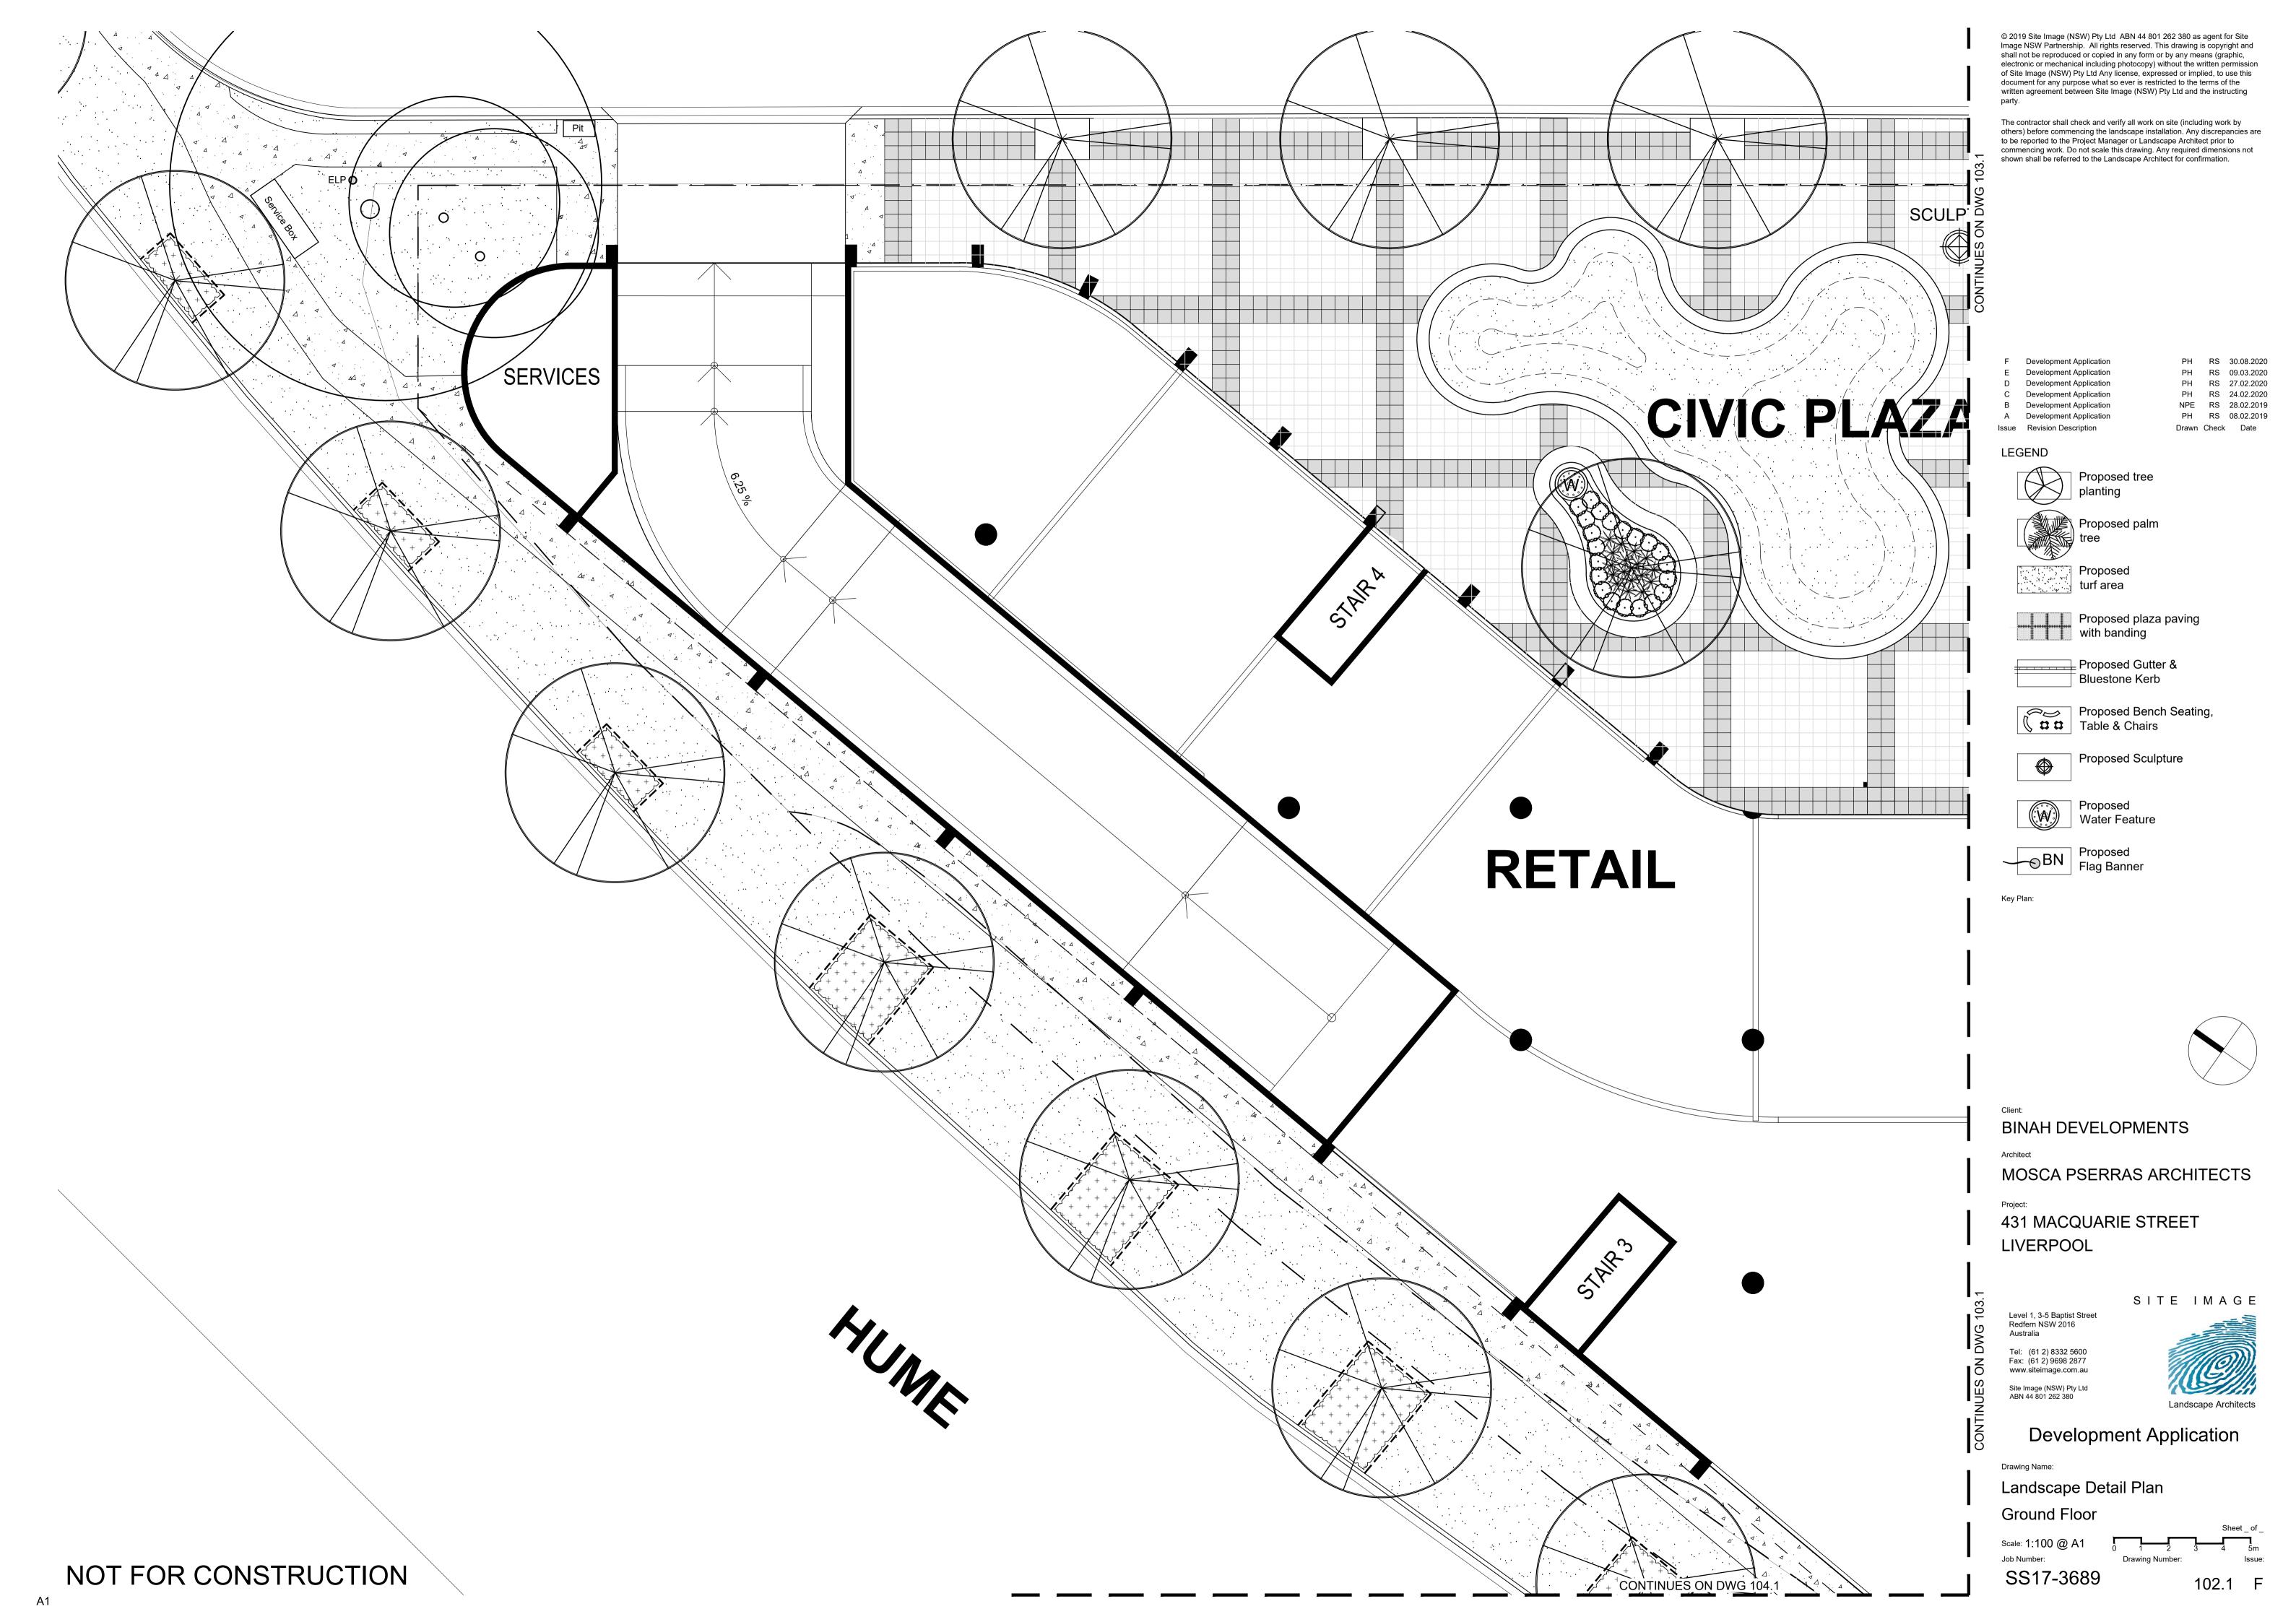



Development Application


Landscape Plan **Ground Floor**

Scale: 1:200 @ A1
Job Number:

SS17-3689 101.1 F



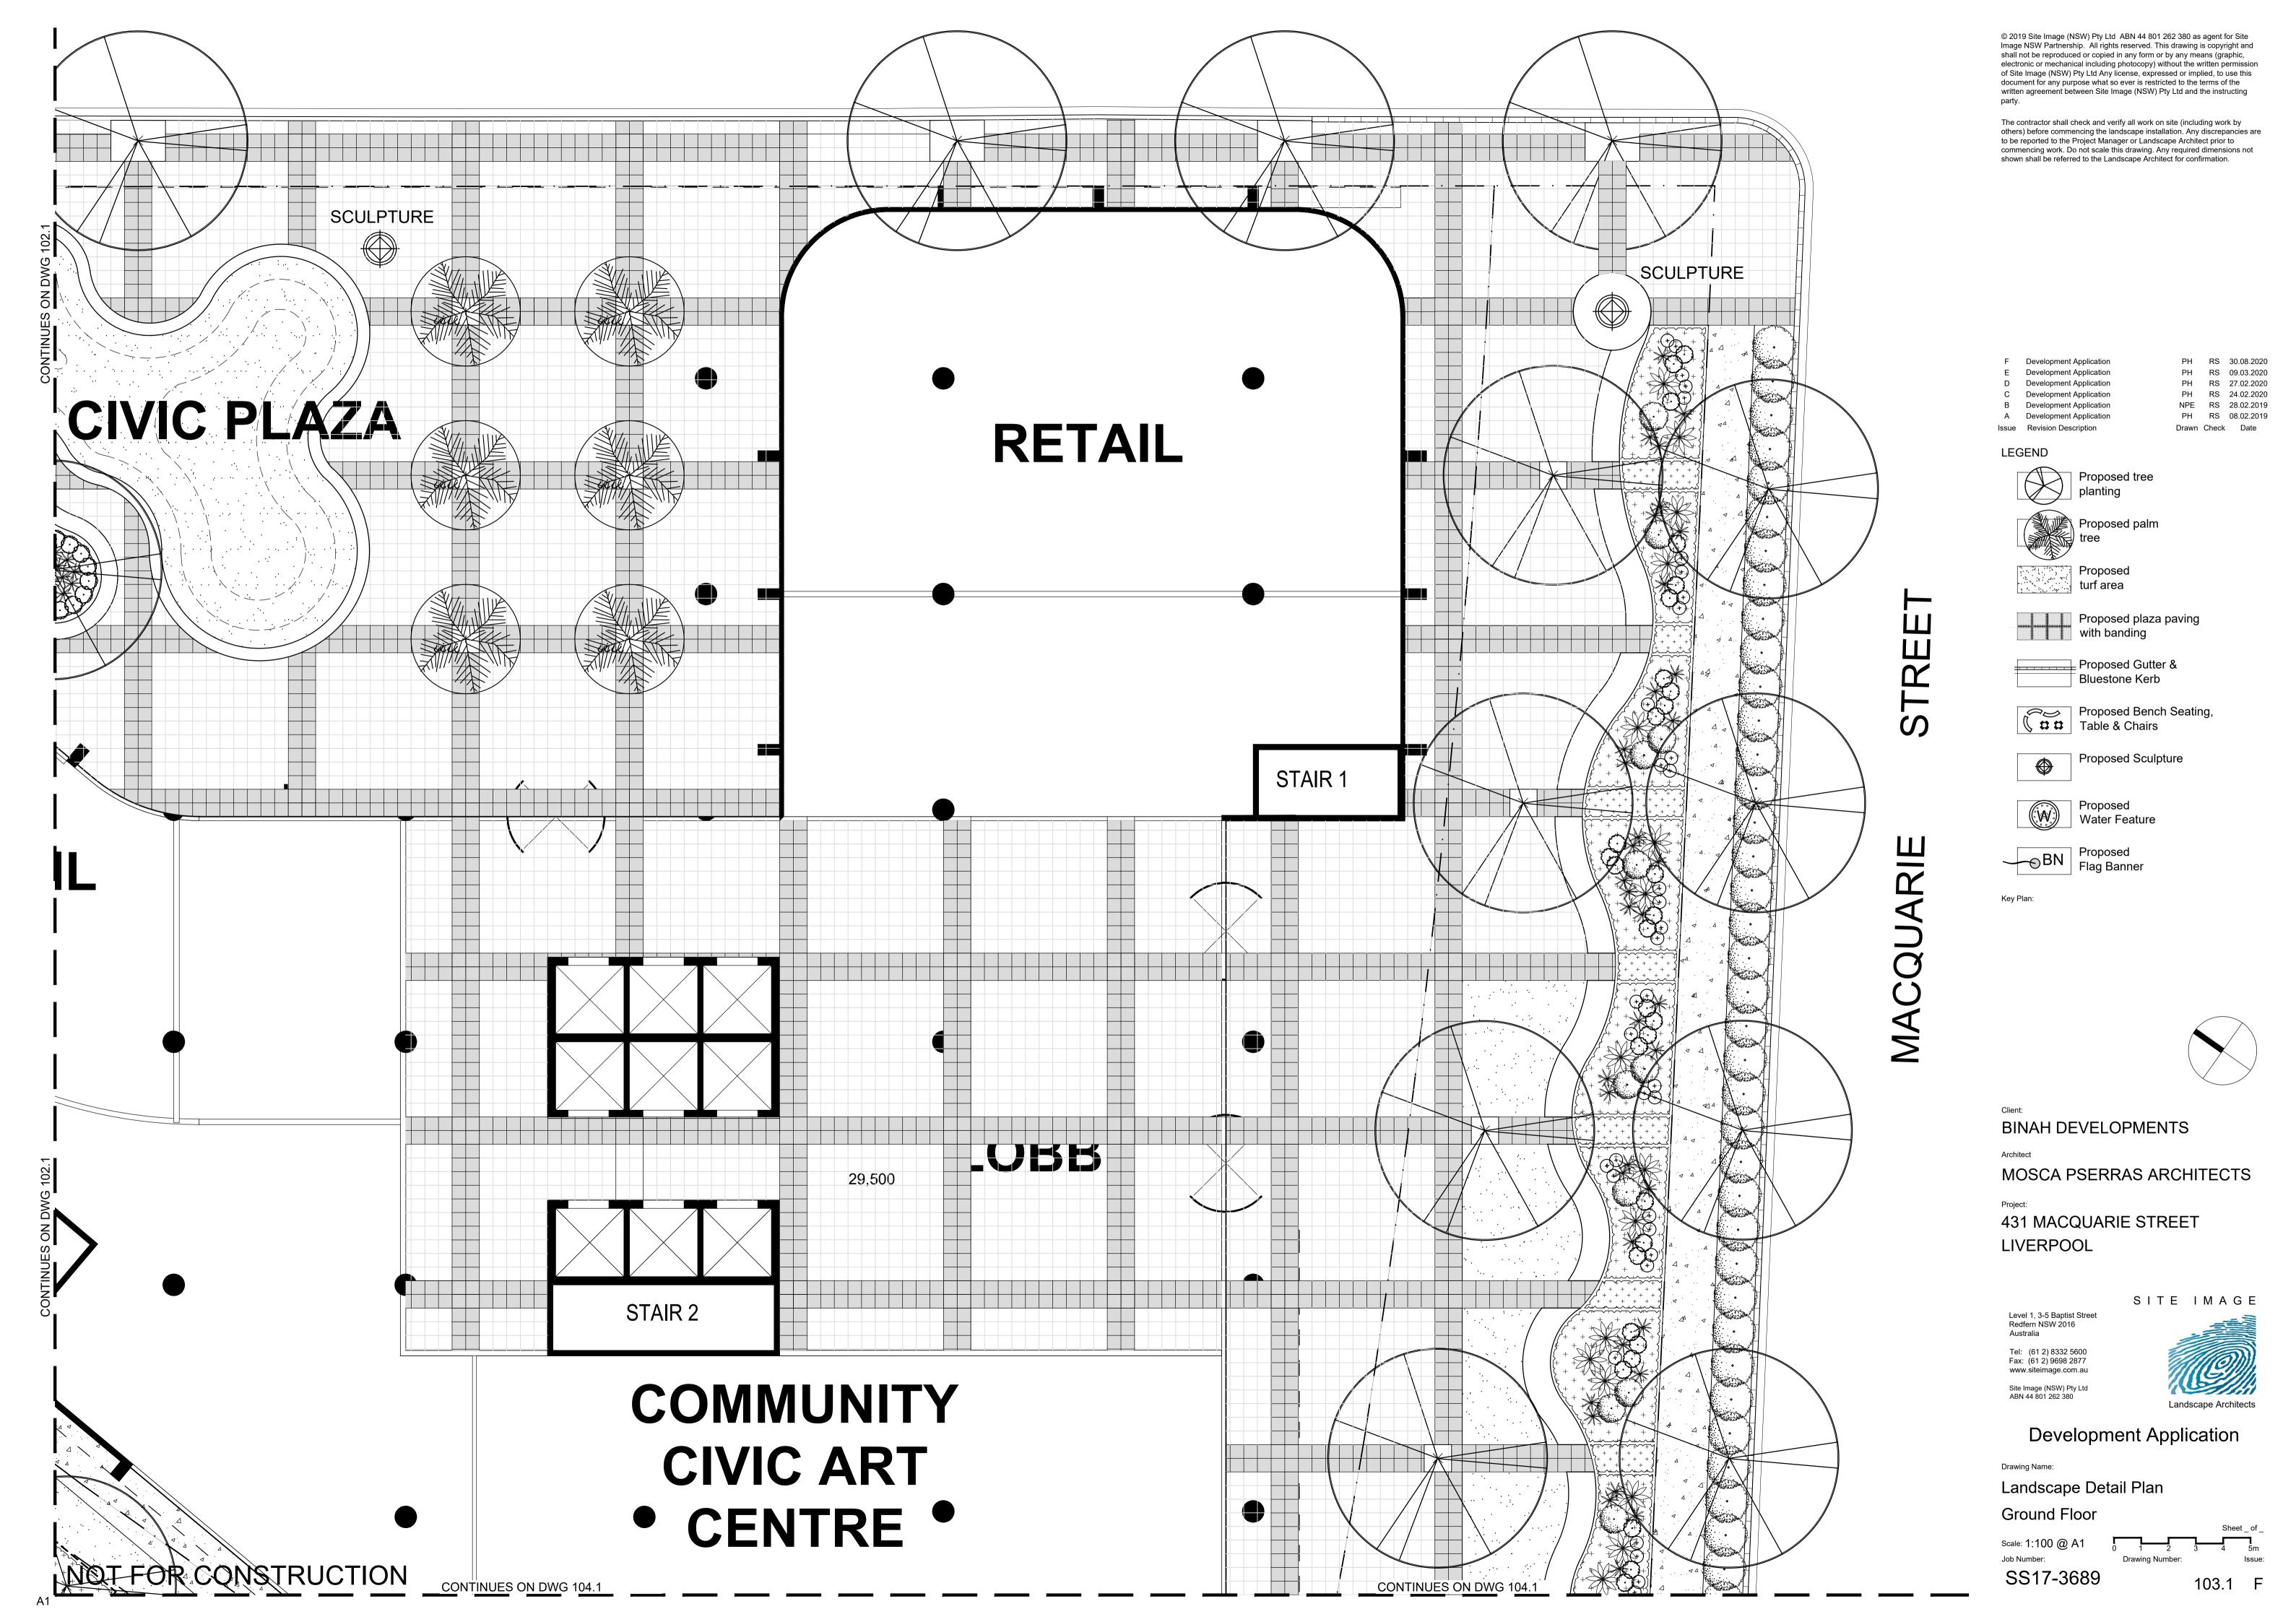

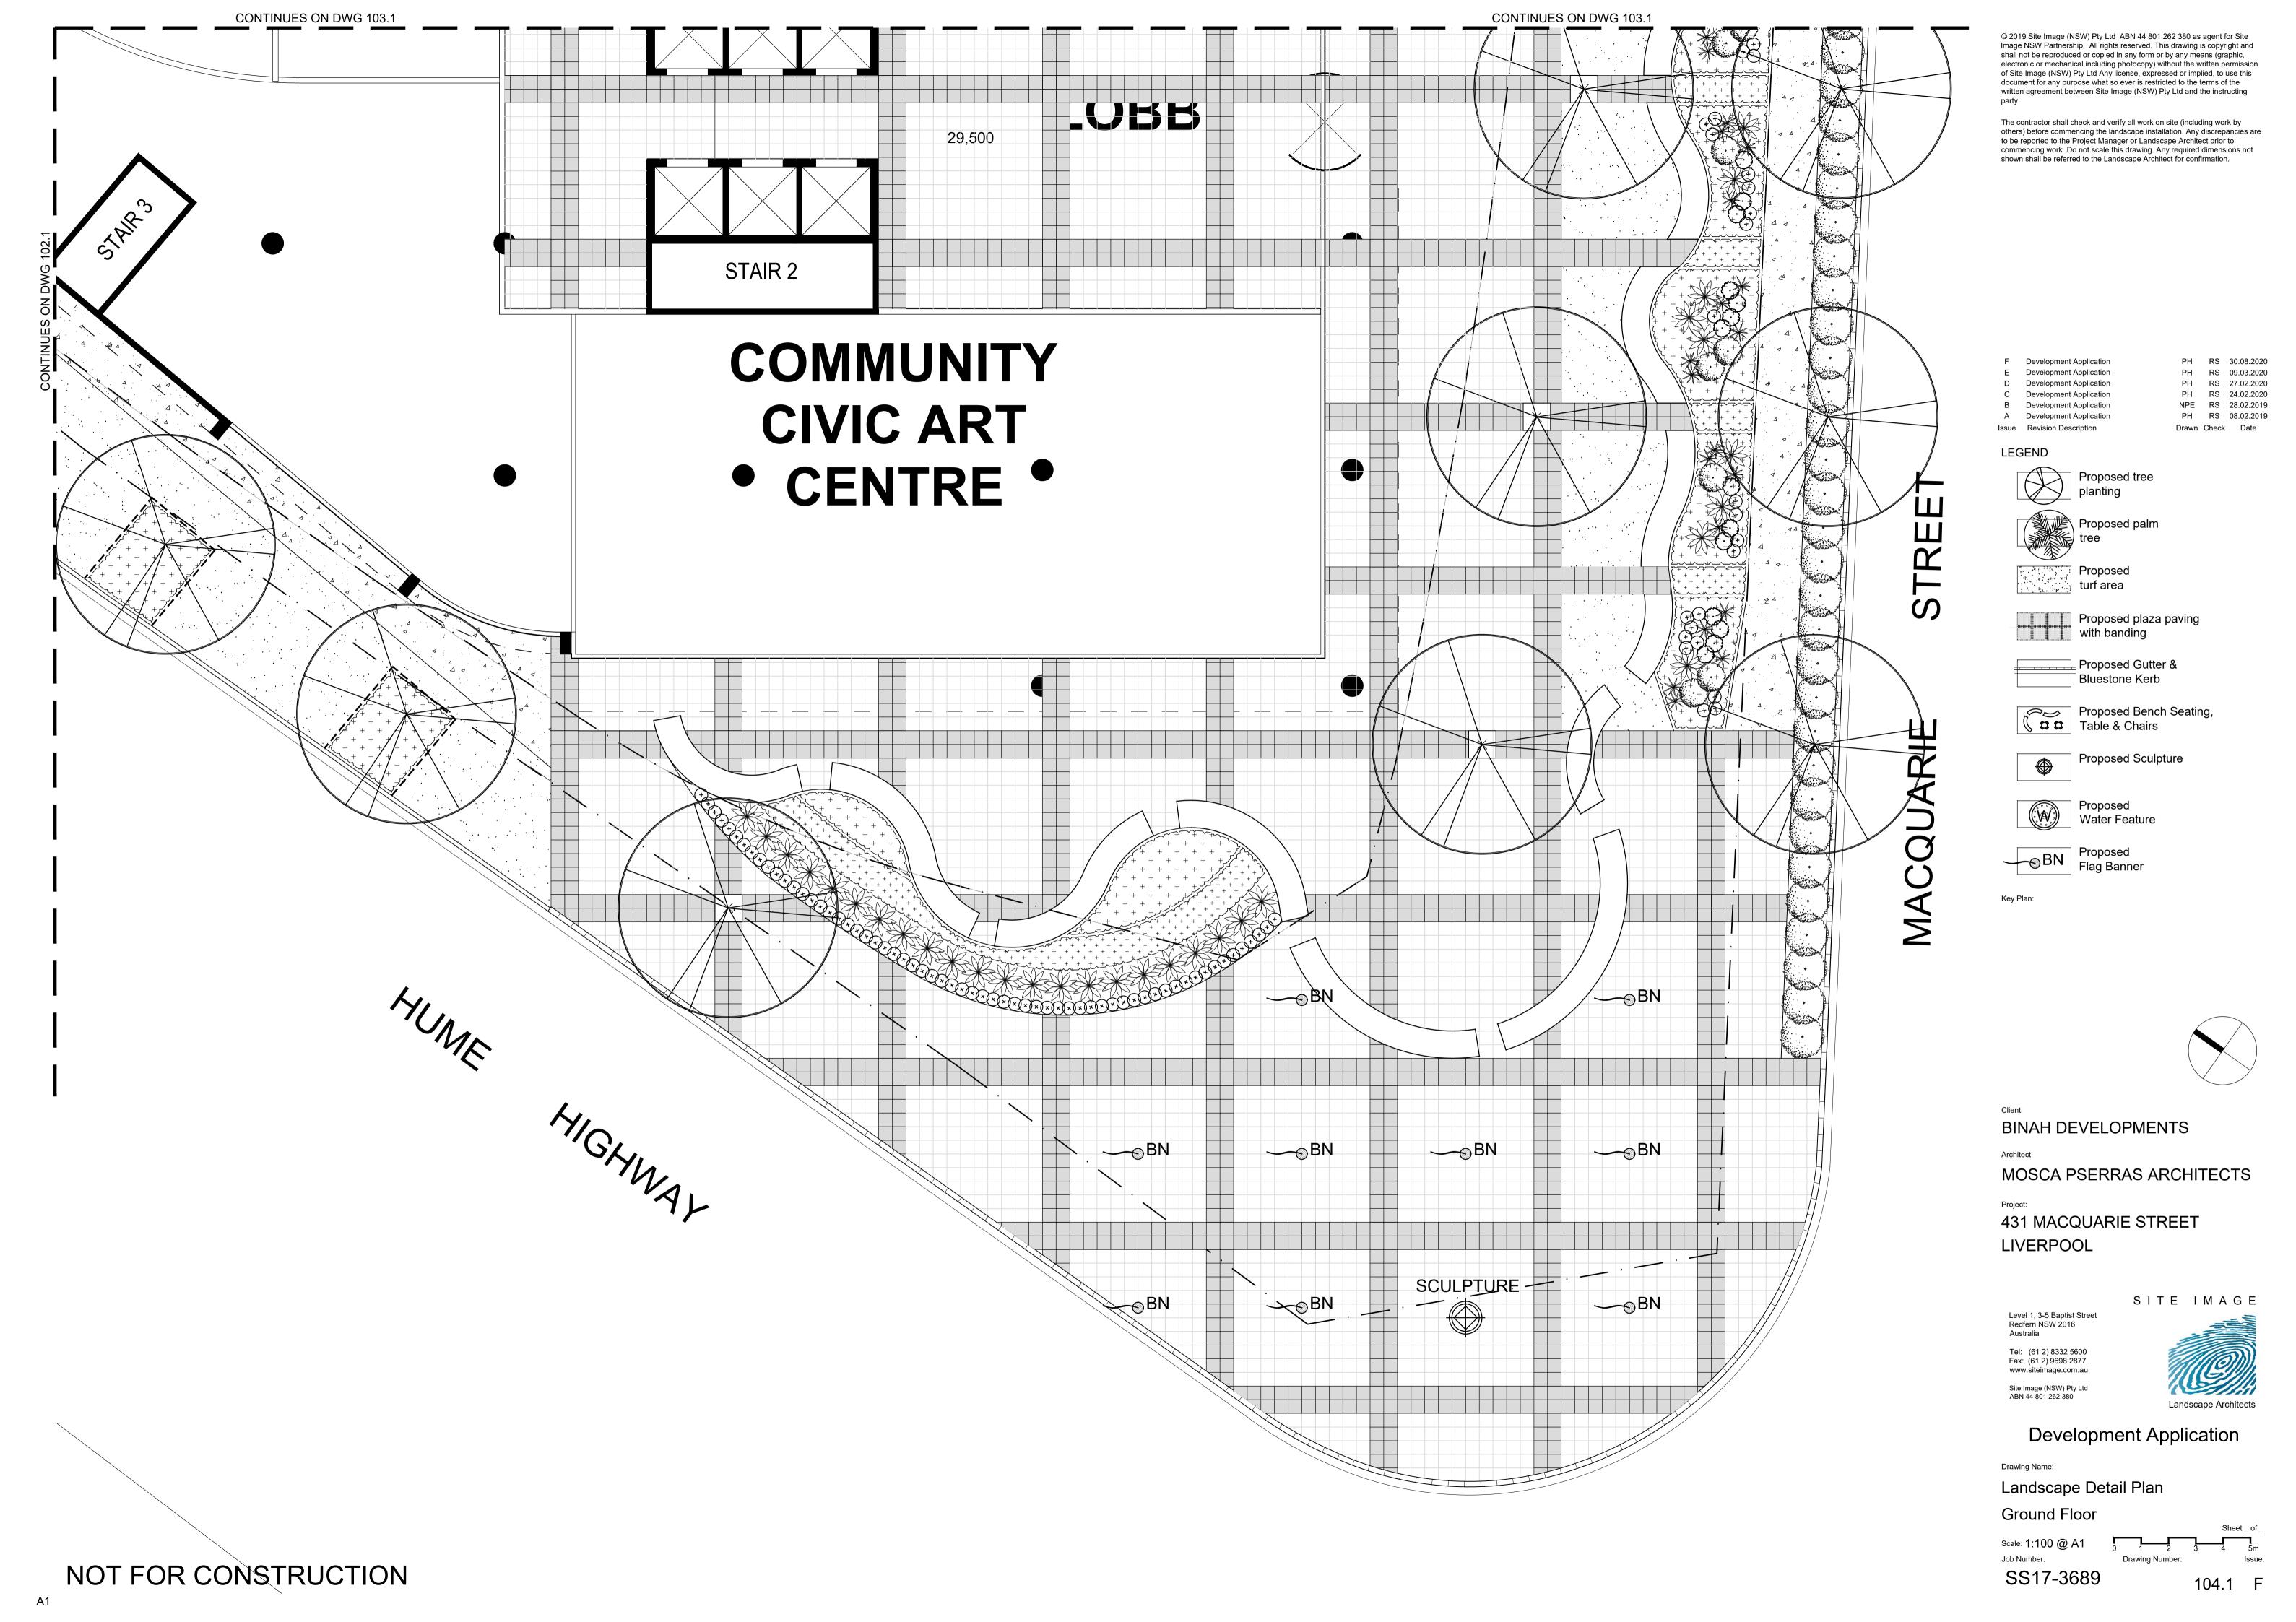

SHORT STREET STAIR 1 **RETAIL** STAIR 2 MACQUARIE RMS FUTURE LAND AQUISITION **WOODWARD PARK**

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D Development Application Development Application B Development Application

PH RS 24.02.2020 NPE RS 28.02.2019 PH RS 08.02.2019 Drawn Check Date

LEGEND

STREET

A Development Application

Issue Revision Description

Proposed

Proposed pot planting

Proposed bench seating / table

Proposed table & chairs

/shade umbrella

Proposed unit paving

BINAH DEVELOPMENTS

MOSCA PSERRAS ARCHITECTS

431 MACQUARIE STREET LIVERPOOL

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105 F


Development Application

Landscape Plan

- Level 4

Scale: 1:200 @ A1
Job Number:

SS17-3689

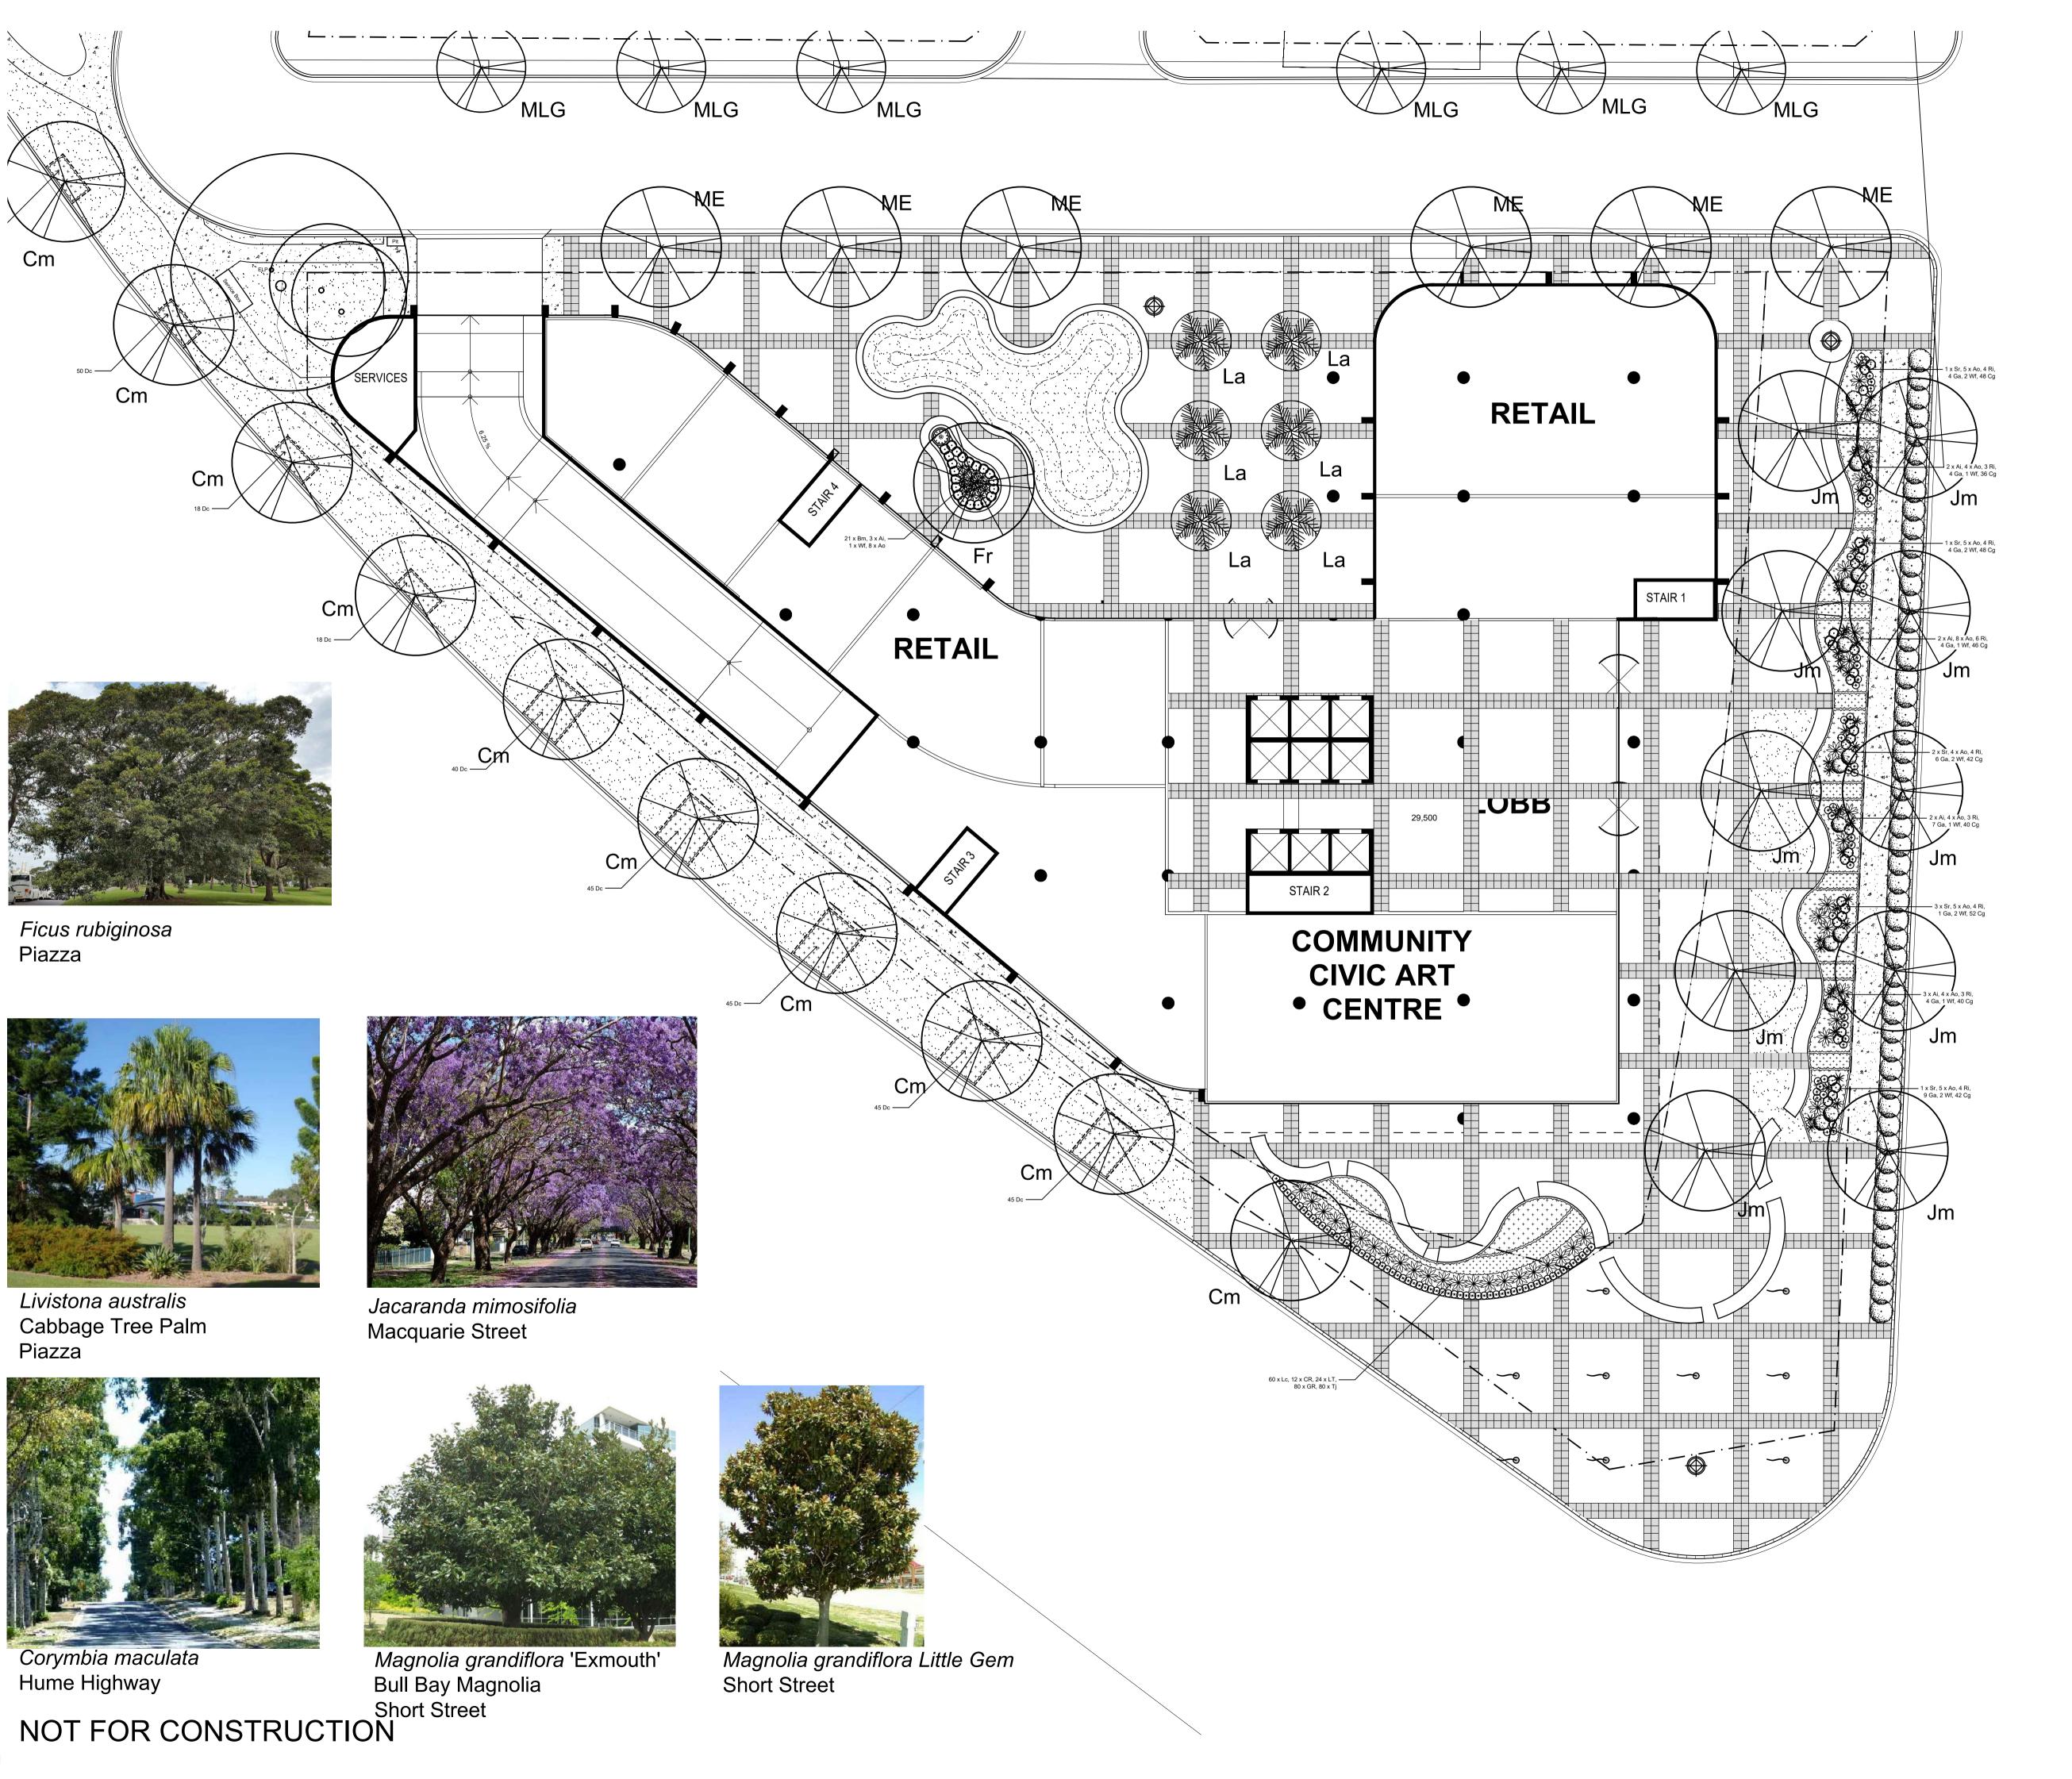

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Development Application PH RS 24.02.2020 **Development Application** NPE RS 28.02.2019 **Development Application** Development Application PH RS 08.02.2019 Issue Revision Description Drawn Check Date

LEGEND

Proposed tree planting Proposed palm

turf area

Proposed plaza paving with banding


Proposed Gutter & Bluestone Kerb

Proposed Bench Seating, Table & Chairs

Proposed Sculpture

Proposed
Water Feature

BN Proposed Flag Banner

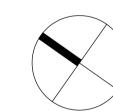

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Development Application

Landscape Planting Plan

- Ground Floor


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SHORT

STREET



RS 24.02.2020 NPE RS 28.02.2019 PH RS 08.02.2019 Drawn Check Date

SPECIFICATION

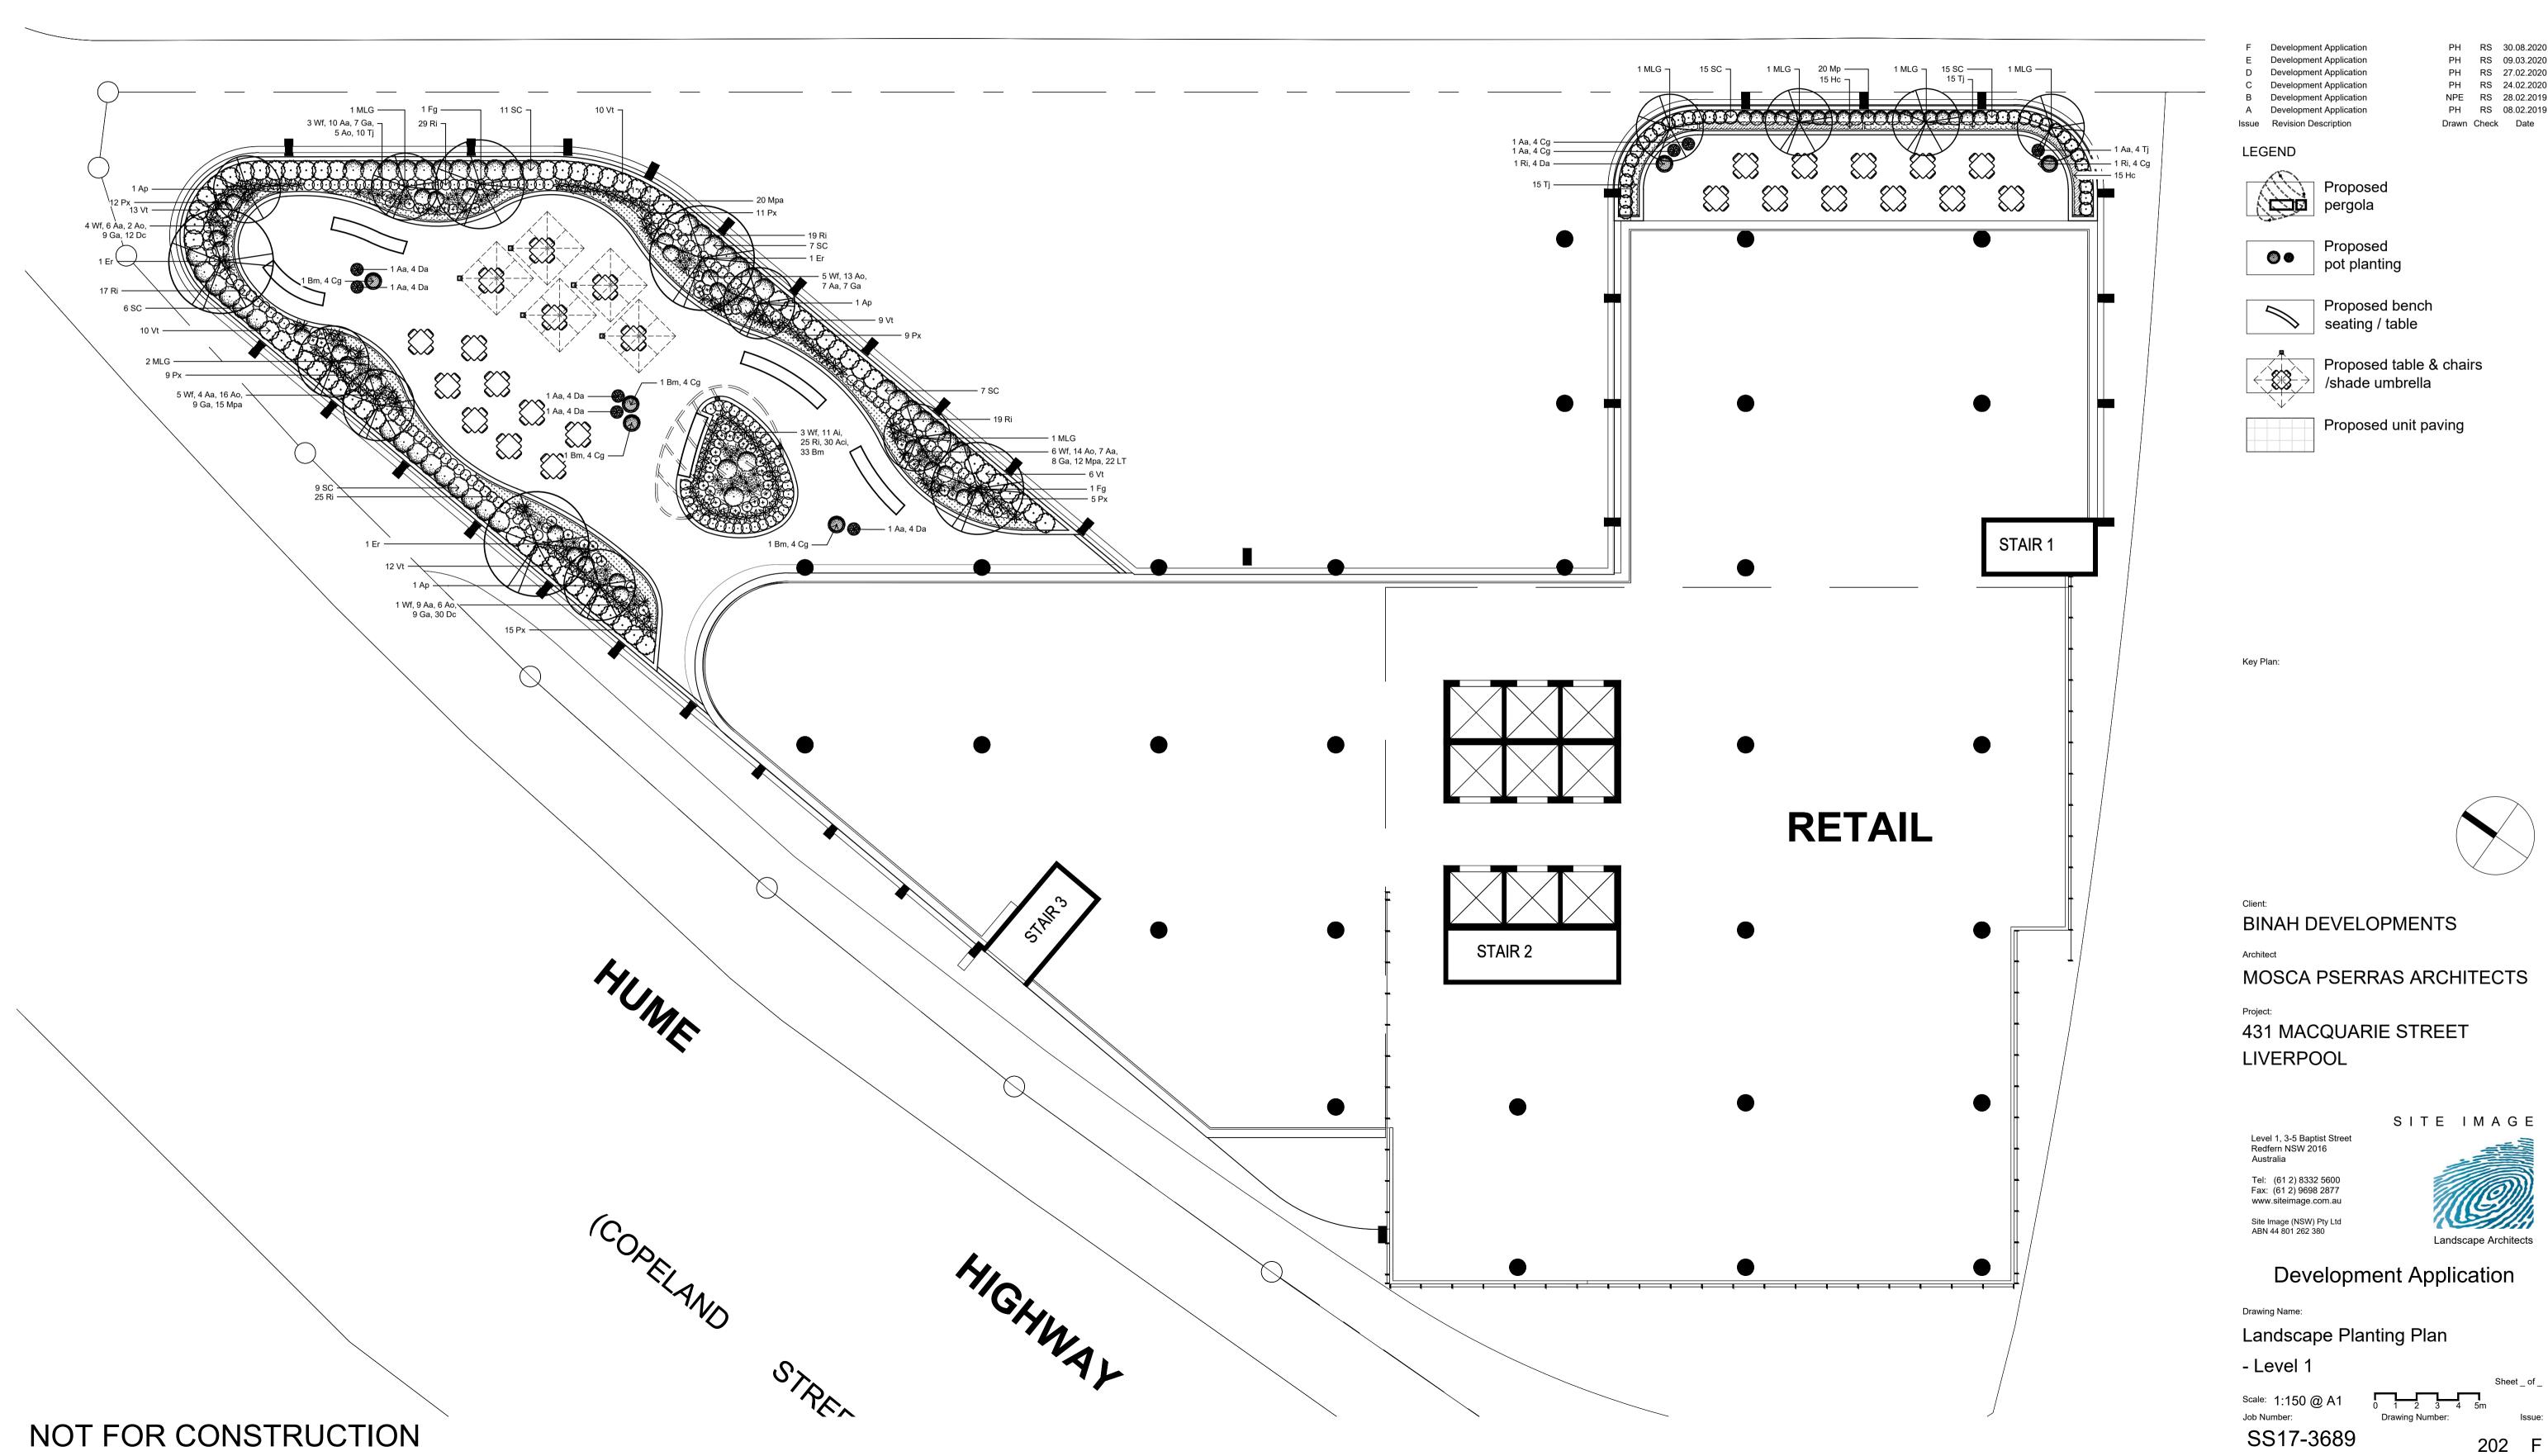GENERAL NOTES

References

All plans and details included in the project documents shall be read in conjunction with this specification. All structural and civil works components of the landscape design shall be referenced to engineers' details and specifications. Read this specification in conjunction with the plant and materials schedules on the drawings. If in doubt about any detail or if conflicts are found in the documents, seek advice.

Workmanship and Materials

The whole of the landscape works shall be carried out by a competent trained and qualified landscape contractor who is experienced in horticultural practices, landscape construction and planting techniques. The landscape contractor shall hold a current Building Contractors License and/or be a financial member of LNA Landscape Association NSW & ACT or equivalent organisations in other states.

EARTHWORKS

Excavation, Trimming and Filling

Except as otherwise noted in the contract, bulk excavation is excluded from the landscape works. After the completion of bulk excavation by others, trim and fill the excavated ground surfaces to achieve design levels to accommodate finish materials as detailed. Prepare the sub-grade surface as required for the various finished ground treatments.

Sub-soil Drainage

Keep the excavated works drained and free of standing water. Allow to supply and install sub-soil drainage pipes as required for the new works to ensure that all gardens are well drained. Connect the sub-soil drainage pipes to the nearest downstream stormwater pits. Include pipe filter socks and course sharp aggregate backfilling of trenches.

HARDWORKS

Furniture, Handrails, Balustrades

Supply and install the scheduled items in accordance with the manufacturer's recommendations, as detailed and in the locations shown on plan. Provide all footings and fixings required for the items to be stable and in accordance with applicable codes and standards.

Garden Walls, Fences, Steps, TGSI and Edging

Construct garden walls, fences, steps, TGSI and edging as shown on plan, as detailed and of the material scheduled. Provide footings, step nosings, tactile surfaces to comply with Australian Standards and applicable legislation. Refer to engineer's details for structural retaining walls, concrete stairs, concrete strength, reinforcing and joint placement

Continuous, Unit and Loose Pavement

Install the scheduled material pavement to the locations shown on plan. Ensure that all subgrade/subsurface works are complete prior to commencing paving. Confer with the engineer to ensure the structural integrity of the subgrade. Ensure that the base course under paved surfaces is a continuous plane offering a constant depth of bedding material not exceeding 50mm. If laying unit pavers in a cement mortar bed on a concrete sub-base ensure that joints in paving match the location of ioints in the concrete. Refer to engineer's details for heavy duty slabs. concrete stairs, concrete strength, reinforcing, and joint type and placement.

SOFTWORKS

Site Soil Testing

Where site soil is to be retrieved from site and stored on site for reuse undertake at least two (2) soil tests in locations as advised by the Project Manager or as shown on the plans. Provide results and recommendations regarding soil additives for the benefit of healthy plant growth and to adjust the soil components to achieve an appropriate planting medium for successful plant development.

Subsoil

Excavate and/or fill all garden beds to bring the top of subsoil to at least 300mm below finished design soil levels. Excavate all turf areas to bring the subsoil to at least 100mm below finished design levels. In all areas shape the subsoil to fall to subsoil drains where applicable. Do not excavate within the drip line of trees and shrubs to be retained. Cultivate or rip the subsoil to a further depth of 100mm before placing top soil. Remove stones of size exceeding 25mm, clods of earth exceeding 50mm, and weeds, rubbish or other deleterious material brought to the surface during cultivation. Do not disturb services or existing tree roots. If necessary cultivate these areas by hand. During cultivation, thoroughly mix in materials required to be incorporated into the subsoil, as recommended in the soil testing results and to manufacturer's recommendations. Trim the surface to design levels again after cultivation.

Import topsoil for the garden and turf areas, unless the topsoil can be provided from material recovered from the site, as recommended in the soil testing results. Spread the topsoil on the prepared subsoil and grade evenly, compact lightly and uniformly in 150mm layers. Avoid differential subsidence and excess compaction and produce a finished topsoil surface which has the following characteristics:

- Finished to design levels, allowing for mulch or turf, which is to finish flush with adjoining hard surfaces such as paths and edges;
- Smooth and free from inorganic matter, stones or clods of soil; • Graded to drain freely, without ponding, to catchment and/or sub-soil
- Graded evenly to adjoining surfaces; and Ready for planting.

Compost

Provide, in accordance with AS 4454, well rotted vegetative material or animal manure, free from harmful chemicals, inorganic matter, grass, weeds and the reproductive parts of unwanted plants.

Provide proprietary fertilisers, delivered to the site in sealed containers marked to show manufacturer or vendor, weight, fertiliser type, N:P:K ratio, recommended uses, application rates and safety procedures. Apply appropriate fertiliser suited to the provenance of plants (indigenous or exotic) included in the design.

Plants

Supply plants in accordance with the landscape design drawings and schedules, which have the following characteristics:

- Large healthy root systems, with no evidence of root curl, restriction or damage;
- Vigorous, well established, free from disease and pests, of good form consistent with the species/variety;
- Hardened off, not soft or forced, and suitable for planting in the natural climatic conditions prevailing at the site in full sun, partial shade or full shade conditions:
- Grown in final containers for not less than twelve weeks;
- Trees, unless required to be multi-stemmed, shall have a single leading shoot; and
- Containers shall be free from weeds and of appropriate size in relation to the specified plant size.

Plant Installation

Following excavation of the planting hole, place and spread 15gms of wetting agent pre-mixed with one (1) litre of water. Place the plant correctly orientated to north or for best presentation. Backfill the planting holes with specified topsoil mixture. Lightly tamp and water to eliminate air pockets. Ensure that the backfill soil is not placed over the top of the root ball and that the root ball is not higher than the soil in which it is planted. Apply fertiliser, as specified around the plants in the soil at the time of planting.

Embankment Stabilisation

Where necessary and shown on the drawings prevent soil erosion or soil movement by stabilising embankments as follows. As a minimum this should be on slopes steeper than or equal to 1:3 gradient. Stabilise embankments using biodegradable fibre reinforced heavy weight jute fabric. Lay fabric from top to bottom of slope. Install in accordance with manufacturer's specification, including 300 x 300mm anchor trench at top and bottom of slope, backfilled with soil over the fabric and compacted into the trenches. Using U-shaped galvanised steel pegs at 1000 mm centres generally and 250mm centres at edge overlaps, secure the fabric to the prepared soil surface. Plant through the fabric after it is installed.

Root Barrier

Supply and install root control barriers to all new tree plantings adjacent to walls, paths, kerbs and all service trenches, where their proximity poses a threat to the stability of the built infrastructure. Install in accordance with manufacturer's recommendations.

Unless noted otherwise, mulch shall be approved proprietary recycled wood fibre or pine bark material. Place mulch in all garden beds to a depth of 75mm after all specified plants are installed. Keep mulch clear of all plant stems and rake to an even plane, flush with the surrounding surfaces evenly graded between design surface levels. Over fill to allow mulch to settle to the specified depth.

Stakes and Ties

Stakes shall be durable hardwood, straight, free of knots and twists, pointed at one end, in the following quantities and sizes for each of the various plant pot sizes:

- Plants >25 It: 1 off 38 x 38 x 1200mm;
- Semi-advanced plants >75 lt: 2 off 50x50x 1800mm;
- Advanced plants >100 lt: 3 off 50 x 50 x 2400mm.

Turf

Turf shall be delivered to site as 25mm minimum thick cut rolls. Obtain turf from a specialist grower of cultivated turf. Turf shall have an even thickness, free from weeds and other foreign matter. Deliver turf to the site within 24 hours of being cut and lay it within 24 hours of delivery. Prevent it form drying out between cutting and laying. Lay the turf in the following manner:

- In stretcher pattern, joints staggered and close butted;
- Parallel long sides of level areas, with contours on slopes; and
- To finish flush, after lightly tamping, with adjacent finished surfaces and
- Species: Stenotaphrum secundatum Sir Walter Soft-leaf Buffalo.

IRRIGATION

Scope: Unless otherwise noted or instructed irrigate all planted areas shown on plans including planters, tubs, gardens, turf and the like.

The irrigation system shall be an automatic permanent system, with an irrigation controller self operated via a soil moisture sensor. The system shall be calibrated to deliver the optimum rate and volume of water appropriate to the type of plants in the design. The system shall be adjustable and fully serviceable. The layout of the entire irrigation system shall focus on delivering the required amount of water to maintain healthy and vigorous growth. The irrigation system shall be such that, component theft, vandalism, over-spray and wetting of paths shall be reduced to a minimum or completely eliminated by the use of drip, pop-up sprinklers and judiciously placed fixed spray emitters. Generally do not use fine mist emitters that provide a drifting mist that may wet paths and the buildings unless specifically required by the design.

LANDSCAPE MAINTENANCE

The Landscape Contractor shall rectify defects during installation and that become apparent in the works under normal use for the duration of the contract Defects Liability Period. Unless contracted otherwise, the Landscape Contractor shall maintain the contract areas by the implementation of industry accepted horticultural practices for 52 weeks from Practical Completion of the works. The landscape maintenance works shall include, but not be limited to:

- Replacing failed plants;
- Pruning:
- Insect and pest control;
- Fertilising;
- Maintaining and removing stakes and ties;
- Maintaining mulch;
- Mowing and top dressing;
- Irrigation and watering; Erosion control; and
- Weeding and rubbish removal.

Maintenance Log Book

Implement and keep a maintenance log book recording when and what maintenance work has been undertaken and what materials, actions and decisions have been used, implemented and concluded to keep the landscape always looking its best. Enter data daily and review information every 2 weeks. Observe trends and develop a maintenance regime around seasonal and observed event occurrences.

Maintenance Activities

During the defects maintenance period schedule the following activities to occur on a timely basis.

- Plant replacement Replace plants that have failed to mature, die or are damaged. Replacement plants shall be in a similar size and quality and identical species or variety to the plant that has failed. Replacement of plants shall be at the cost of the landscape contractor unless advised otherwise. If the cause of the failure is due to a controllable situation then correct the situation prior to replacing plants. Observe and replace failed plants within 2 weeks of observation.
- Pruning Prune dead wood, broken limbs, dead or infected foliage and as needed to develop strong, healthy plants to achieve the shape and form expected of the plant type. Observe daily and prune plants on a needs basis
- Insect, disease and pest control Avoid spraying:
- o if ever possible
- in wet weather or if wet weather is imminent; if target plants are still wet after rain;
- in windy weather; and
- if non-target species are too close.

Immediately report to the Project Manager any evidence of intensive weed infestation, insect attack or disease amongst plant material. Submit all proposals to apply chemicals and obtain approval before starting this work. When approved, spray with herbicide, insecticide, fungicide as appropriate in accordance with the manufacturers' recommendations. Observe daily and act as necessary to control any infestation or disease. Record in the logbook all relevant details of spraying activities including:

- Product brand / manufacturer's name,
- Chemical / product name, Chemical contents,
- Application quantity and rate,
- Date of application and location,
- Results of application, and
- Use approval authority.
- Fertilising Fertilise gardens with a proprietary slow release fertiliser applied in accordance with the manufacturer's directions and recommendations. Apply 6-12 monthly. Record in the logbook all relevant details of fertilising including:
 - Product brand / manufacturer's name,
- Fertiliser / product name,

at least every 2 weeks.

SS17-3689 431 Macquarie Street Liverpool

Indicative Plant Schedule

Trees & Palms

Corymbia maculata

icus rubiginosa

ivistona australis

lacaranda mimosifolia

Shrubs and Accents

Alcantarea imperialis

Raphiolepis indica

Vestringia fruticosa

Carpobrotus glaucescens

Agapanthus orientalis

Strelitzia reginae

Lc

SC

LT

Mpa

Level 4 Terrace

Trees Acer palmatum

lagnolia grandiflora Exmouth

Magnolia grandiflora Little Gem

uxus microphylla Japonica

Cordyline fruticosa Ruby

Gardenia augusta Florida

Gardenia augusta 'Radicans'

Groundcovers and Grasses

∟omandra longifolia Tanika

Trachelospermum jasminoides

Lomandra longifolia Tanika

Magnolia grandiflora Little Gem

luxus microphylla Japonica

Groundcovers and Grasses

Dichondra argentea Silver Falls

rachelospermum jasminoides

Gardenia augusta Florida

laeocarpus reticulatus

Shrubs and Accents

Alcantarea imperialis

Murraya paniculata

Raphiolepis indica

relitzia reginae

/iburnum tinus

Syzygium 'Cascade'

Vestringia fruticosa

Carpobrotus glaucescens

Philodendron 'Xanadu'

Philodendron 'Xanadu

lyoporum parvifolilum

omandra 'Tanika'

Dianella caerulea

raxinus griffithii

Agave attenuata

Dianella caerulea 'Breeze' Native Flax

Symbol | Botanic Name

Ground Floor Plaza

- Application quantity and rate, and Date of application and location.
- Stakes and ties Adjust and replace as required to ensure plants remain correctly staked. Remove those not required at the end of the planting establishment period (Defects Liability Period). Inspect and act
- Maintaining mulch Maintain the surface in a clean, tidy and weed free condition and reinstate the mulch as necessary to ensure correct depth as specified. Observe weekly and replenish mulch as required.
- Mowing and top dressing Mow the turf to maintain a grass height of between 30-50mm. Do not remove more than one third of the grass height at any one time. Remove grass clippings from the site after each mowing. Top dress to a maximum of 10mm to fill depressions and hollows in the surface. Mow weekly/fortnightly in warmer months. Mow monthly or as required in cooler months. Top dress at approximately 6
- Irrigation and watering Maintain the irrigation system to sure that each individual plant receives the required amount of water to maintain healthy and vigorous growth. Adjust and calibrate as required. Provide additional watering, if necessary but inspect irrigation weekly and make repairs as necessary.
- Erosion control Where necessary, maintain the erosion control fabric in a tidy and weed free condition and reinstate as necessary to ensure control measures are effective where deemed necessary. Inspect every 2 weeks and act to repair any damage as soon as possible.
- Weeding and rubbish removal During the plant establishment period remove by hand, rubbish and weed growth that may occur or re-occur throughout all planted, mulched and paved areas. The contractor shall target weeds that are capable of producing a major infestation of unwanted plants by seed distribution. Whenever possible, time weed removal to precede flowering and seed set. Constant observation and removal of weeds is essential

Common Name

Spotted Gum

Port Jackson Fig

Cabbage Tree Palm

_ittle Gem Magnolia

Gardenia Radicans

Indian Hawthorn

Bird of Paradise

Pig Face

African Lilv

Native Flax

Purple Pixie

Star Jasmine

Japanese Maple

Blueberry Ash

Evergreen Ash

Giant Bromeliad

Japanese Box

Mock Orange

ndian Hawthorr

Bird of Paradise

_aurestinus

Coastal Rosemary

Dwarf Philodendron

Canary Islanda Ivy

Dwarf Philodendron

Creeping Boobialla

Blue Flax Lily

Star Jasmine

Fine Leaf Dwarf Lomandra

Dichondra Silver Falls

Pink Flowering Lillypill

Little Gem Magnolia

Coastal Rosemary

Southern Magnolia

Pot size

400 L

400 L

5m Clear Trunk

400 L

400 L

100 L

300mm

300mm

300mm

300mm

300mm

300mm

300mm

150mm

150mm

150mm

150mm

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150mm

150mm

356

24

136

24

22

47

42

44

Mature Size

(h x w) (m)

30 x 8

20 x 20

25 x 4

12 x 8

5 x 3

 1.5×1.5

 2.0×1.0

 1.5×1.5

 0.5×0.8

1.5 x 1.5

1.2 x 1.5

2.0 x 2.0

0.2 x 1.0

1.0 x 0.5

 0.5×0.5

 0.5×0.5

 0.5×0.8

 0.6×6

6 x 3

5 x 3

12 x 5

8 x 4

 1.5×1.5

1.5 x 1.5

1.5 x 1.5

 1.5×1.5

 3.0×12.0

 1.5×1.5

2.5 x 2.0

1.2 x 1.5

2.0 x 2.0

3.0 x 2.0

0.2 x 1.0

1.0 x 1.0

0.3 x 1.0

 0.3×2.0

1.0 x 1.0

 0.5×0.5

 0.4×1.5

 0.5×0.5


0.6 x 6

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PH RS 30.08.2020 **Development Application** RS 09.03.2020 Development Application PH RS 27.02.2020 Development Application RS 24.02.2020 Development Application NPE RS 28.02.2019 A Development Application PH RS 08.02.2019 Issue Revision Description Drawn Check Date

LEGEND



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Development Application

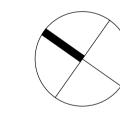
Drawing Name: Landscape Specifications / Plant Schedule

Job Number:


SS17-3689

NOT FOR CONSTRUCTION


500 F

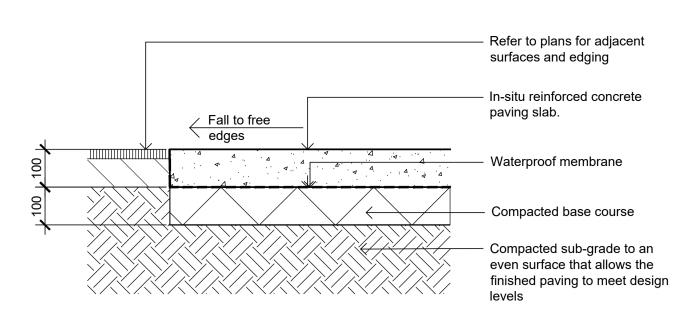


Insitu Concrete Paving - On grade

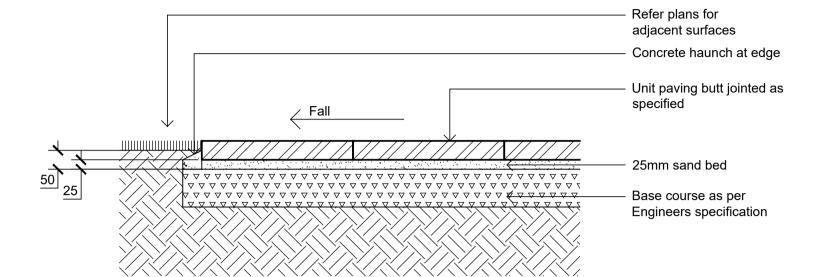


02 Unit Pavers on Grade

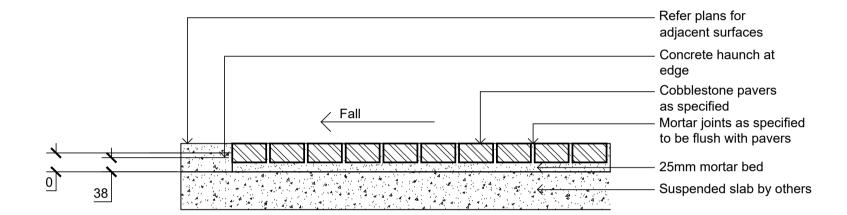


Cobblestone Pavers on Slab

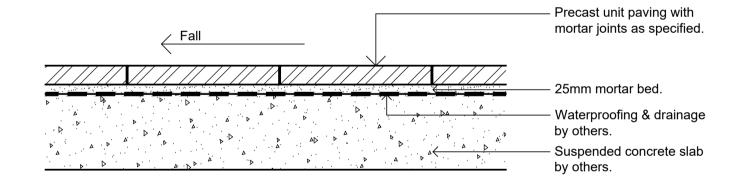


Precast Unit Pavers on Suspended Slab 501 / 1:10

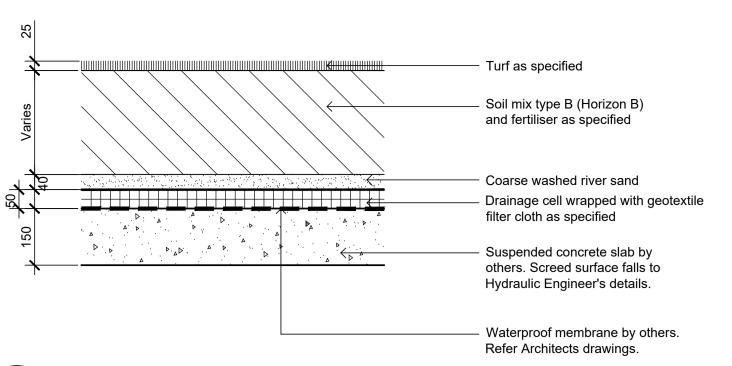


Detail Turf on Suspended Structure

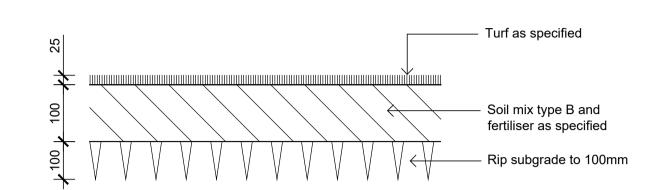

Detail Turf on Even Grade

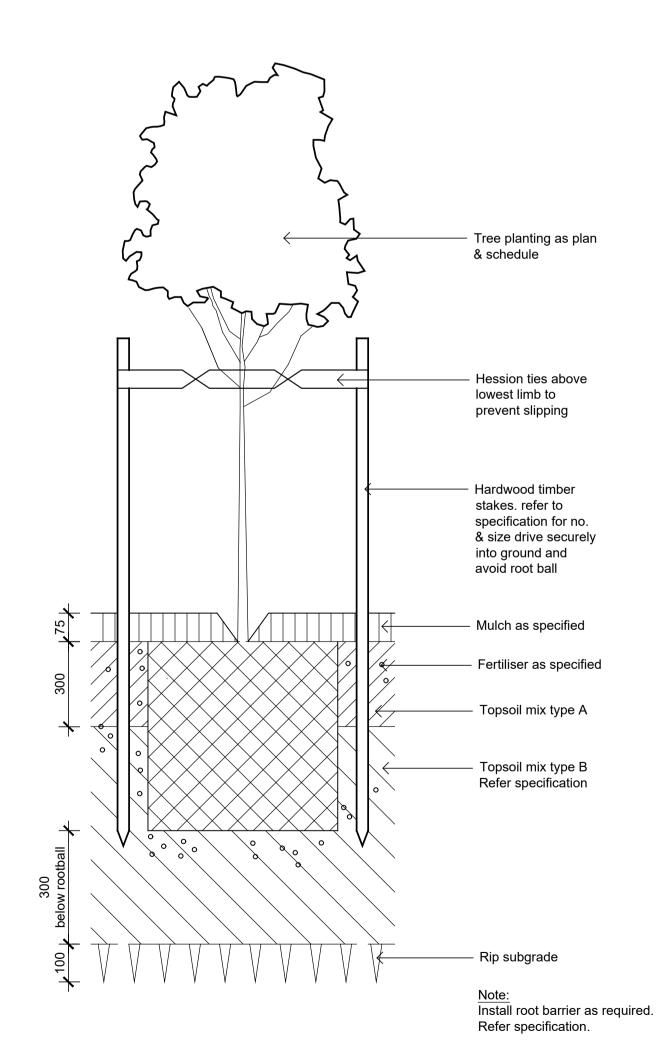

Detail 75-200L Tree Planting on Grade

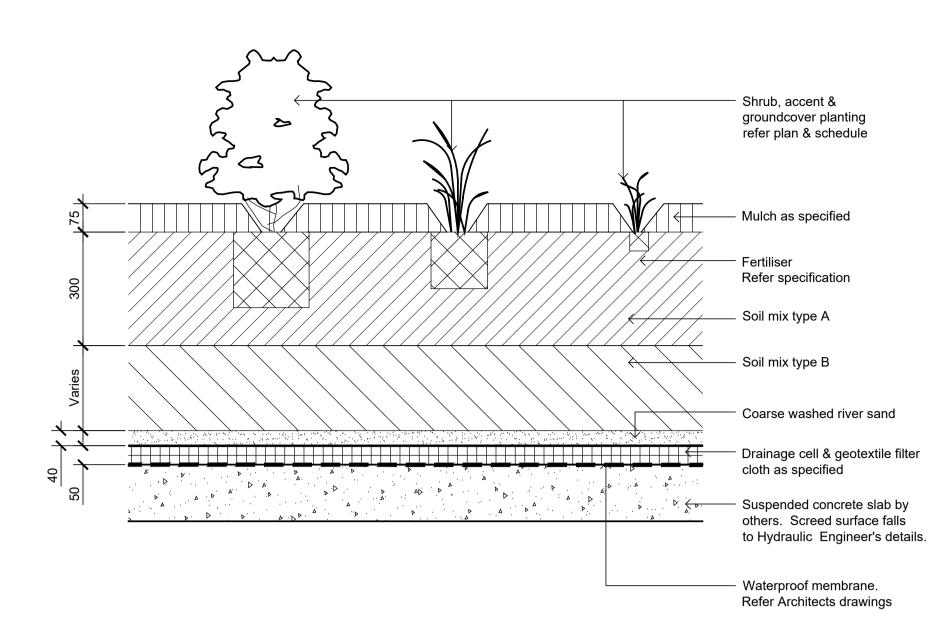

08 Detail Shrub Accent & Groundcover Planting on Structure

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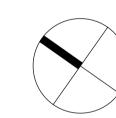
> **Development Application** RS 09.03.2020 Development Application **Development Application** Development Application Development Application

RS 27.02.2020 PH RS 24.02.2020 NPE RS 28.02.2019 PH RS 08.02.2019 Drawn Check Date

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Issue Revision Description



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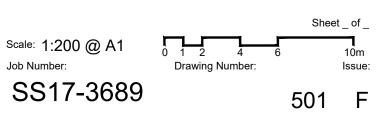
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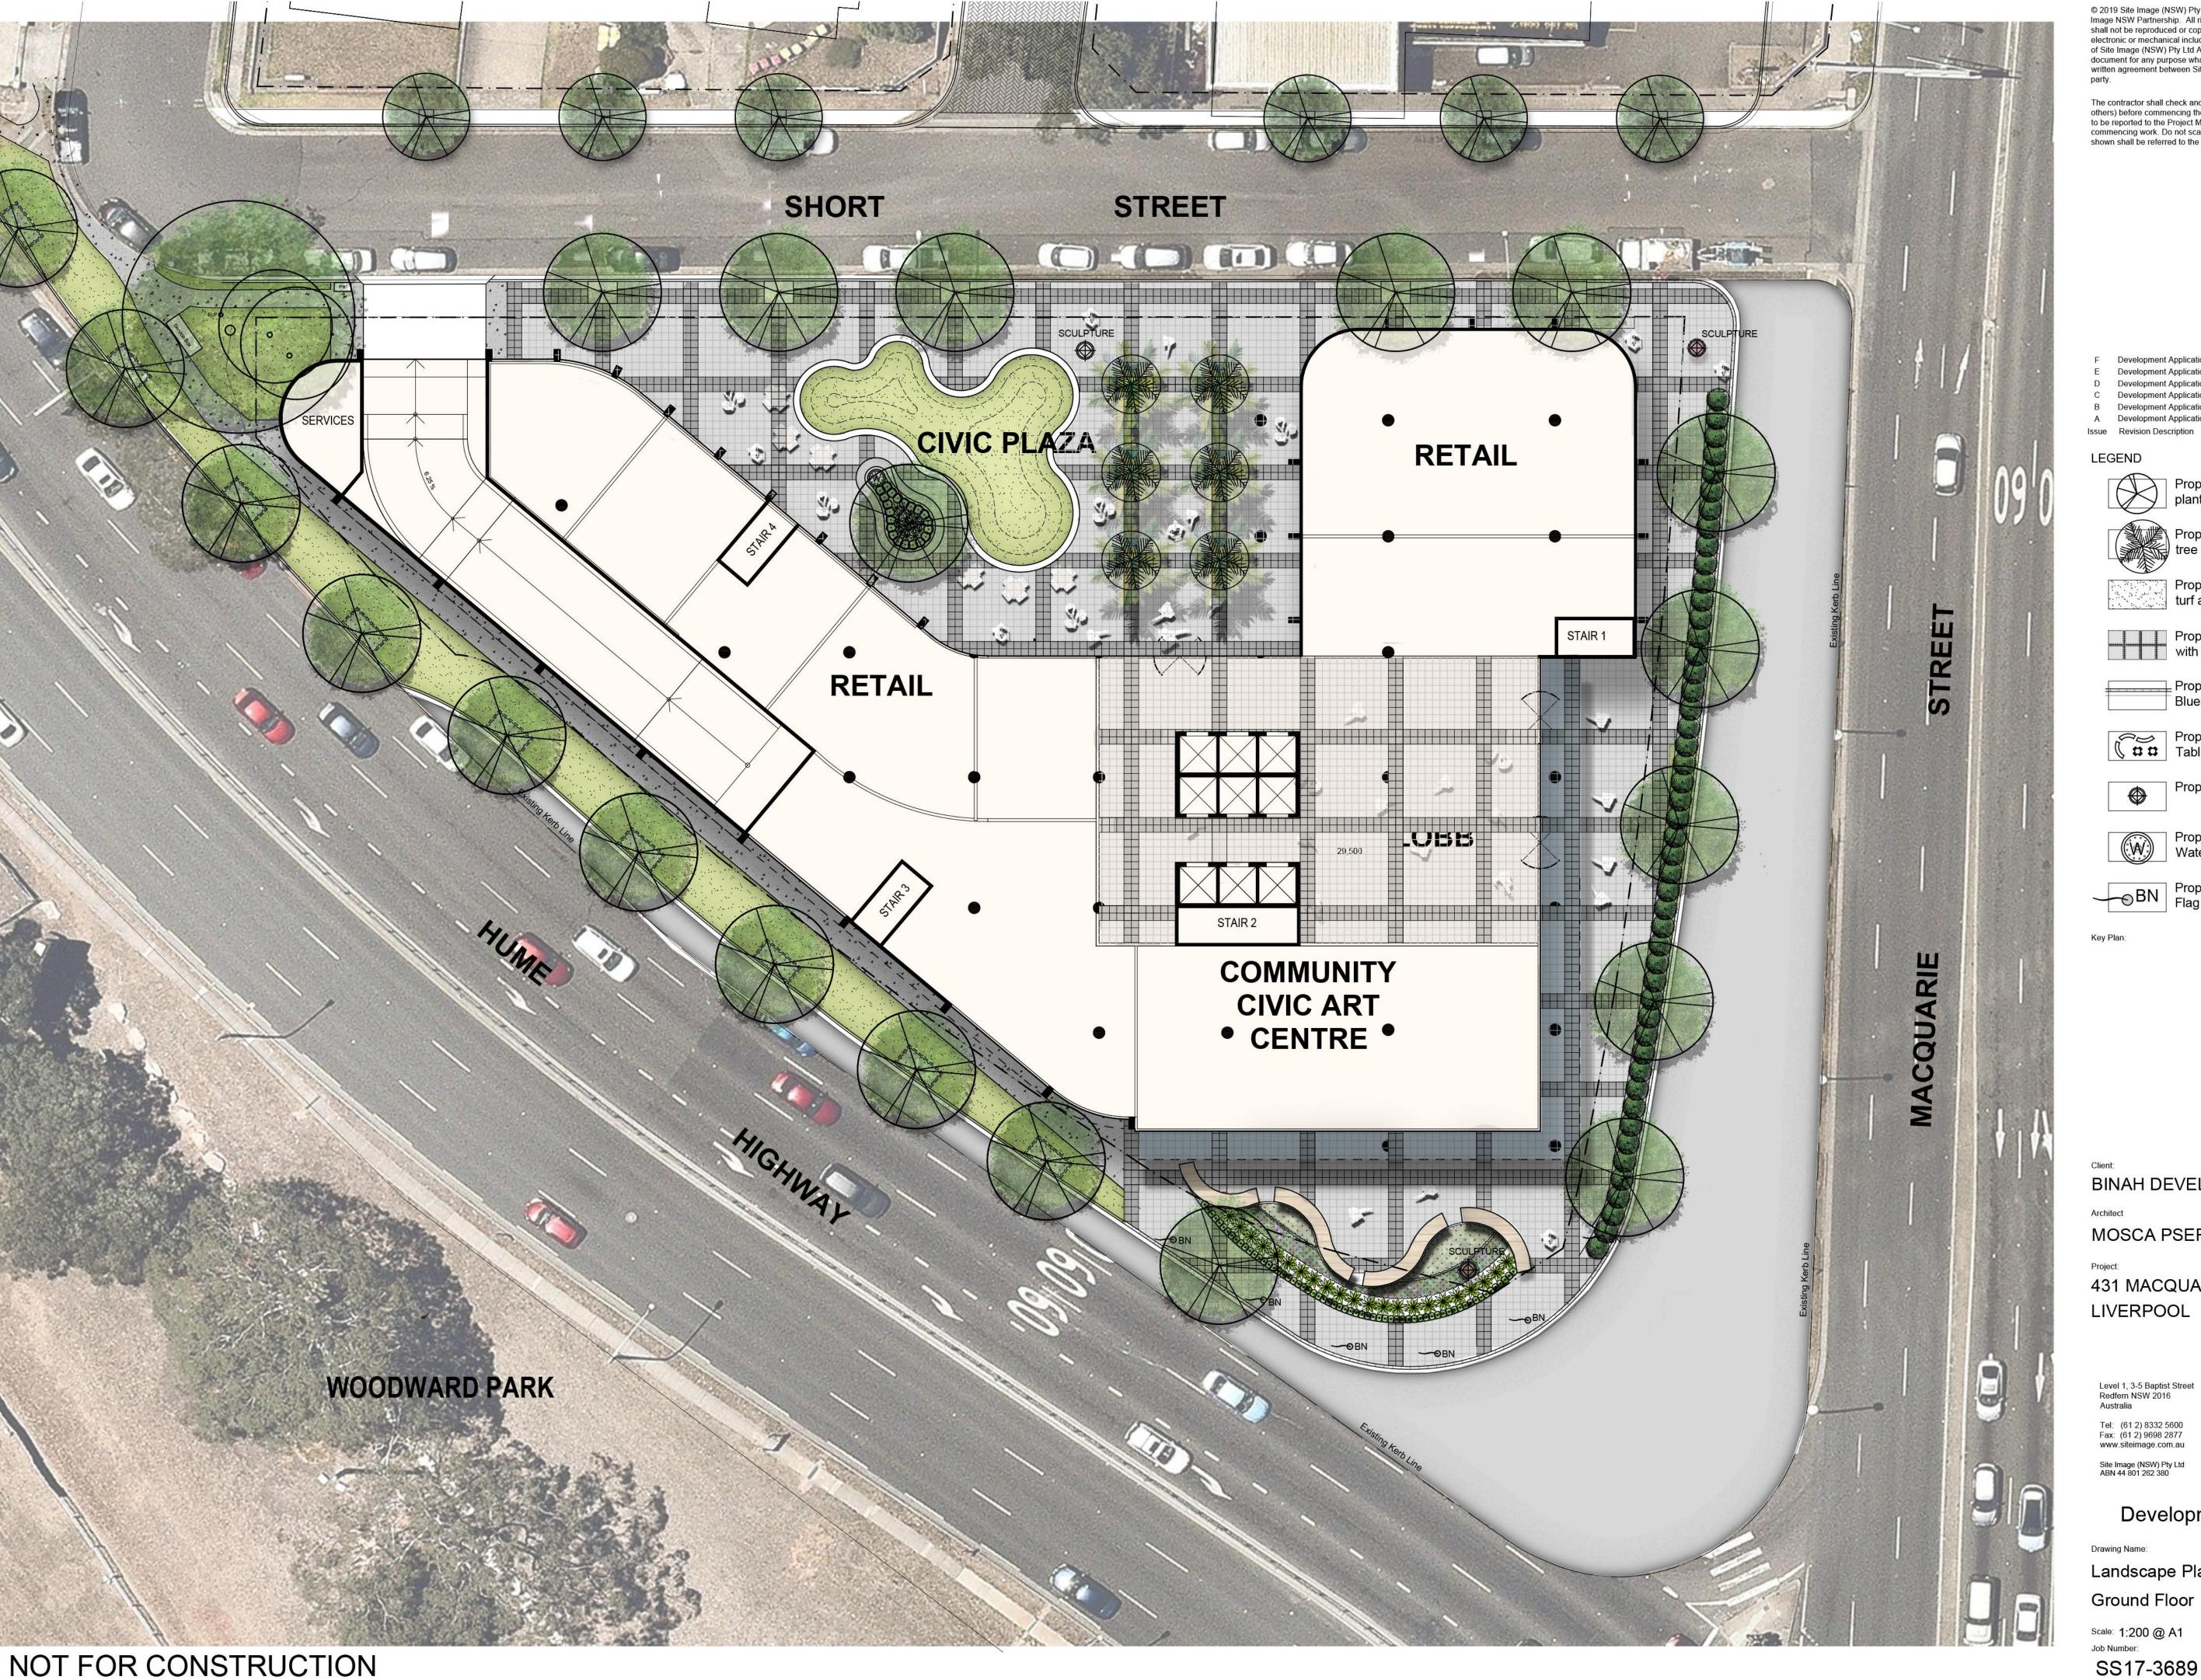
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Drawing Name: Landscape Details





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Development Application Development Application Development Application **Development Application** Development Application A Development Application

 PH
 RS
 30.08.202

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 RS
 09.03.202

 PH
 RS
 27.02.202

 PH
 RS
 24.02.202

 NPE
 RS
 28.02.201

 PH
 RS
 08.02.201

 Drawn
 Check
 Date

LEGEND

Proposed tree

Proposed palm

Proposed turf area

Proposed plaza paving with banding

Proposed Gutter & Bluestone Kerb

Proposed Bench Seating, Table & Chairs

Proposed Sculpture

Proposed Water Feature

BN Proposed Flag Banner



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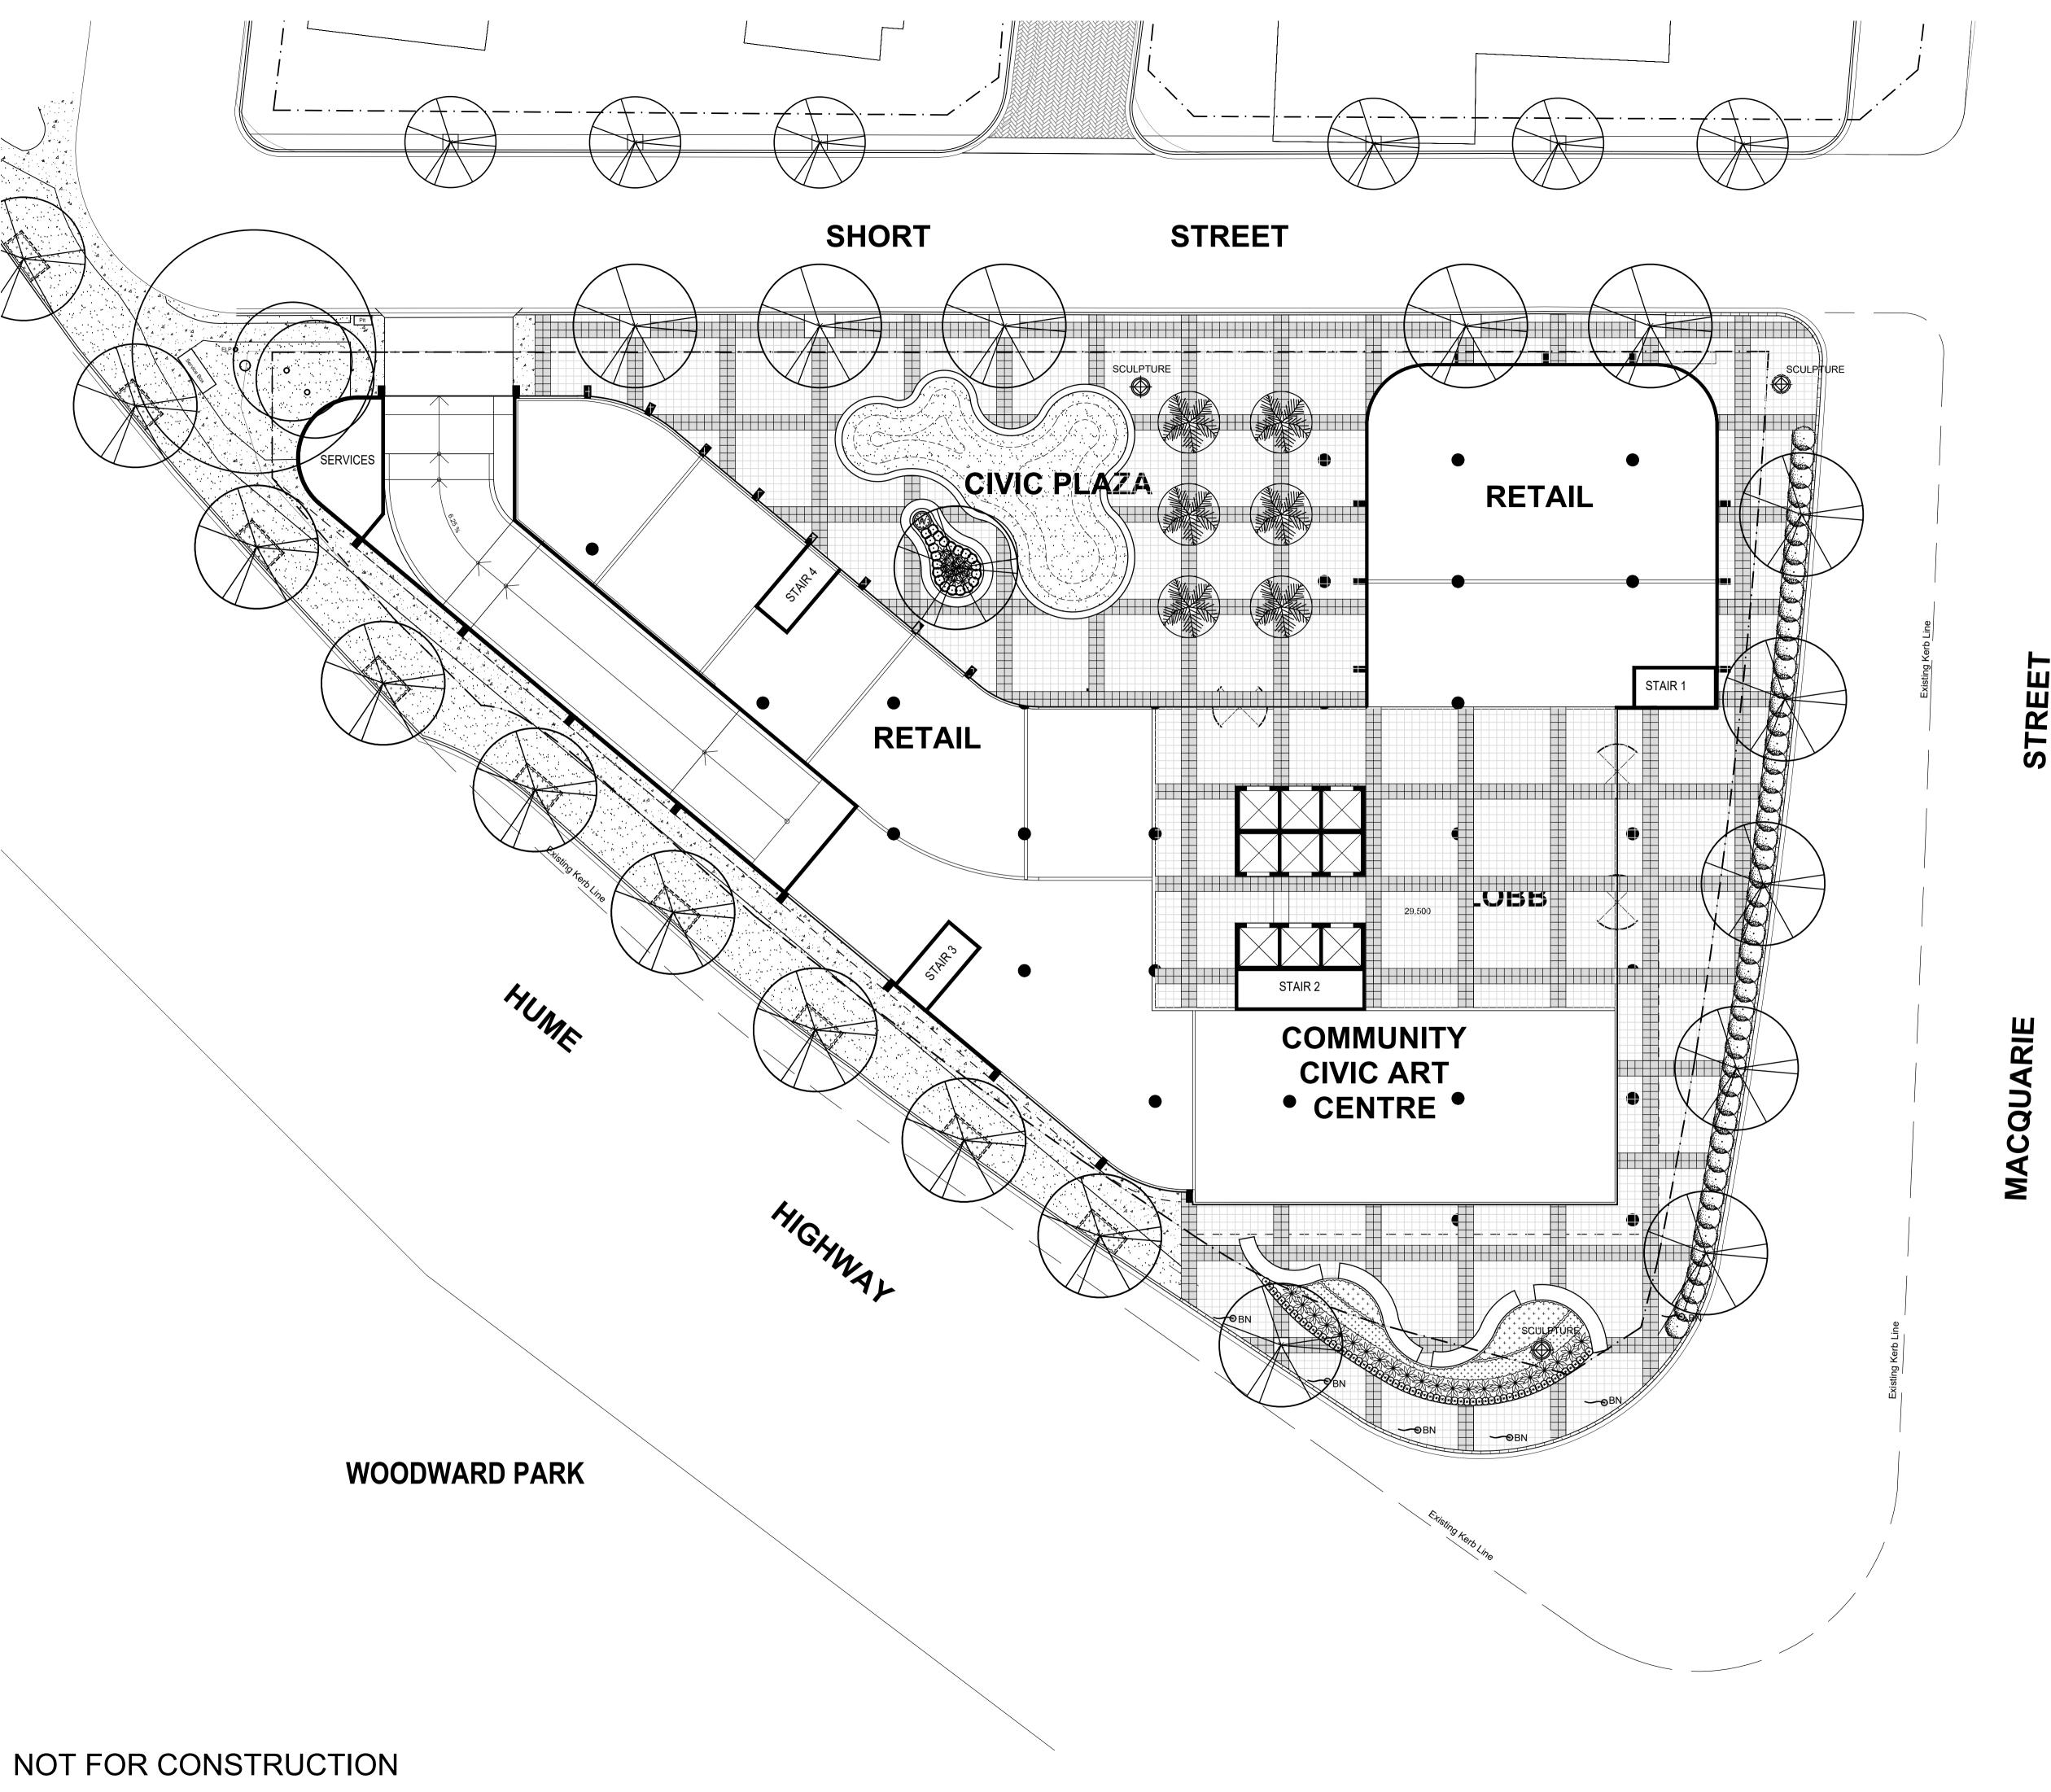


Development Application

Landscape Plan - (Future)

Ground Floor

Scale: 1:200 @ A1



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Development Application Development Application Development Application

Development Application

A Development Application

Issue Revision Description

PH RS 24.02.2020 NPE RS 28.02.2019 PH RS 08.02.2019

Drawn Check Date

LEGEND

Proposed tree planting Proposed palm

turf area Proposed plaza paving with banding

Proposed Gutter &

Bluestone Kerb

Proposed Bench Seating,

Proposed Sculpture

Proposed
Water Feature

BN Proposed Flag Banner

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SITE IMAGE

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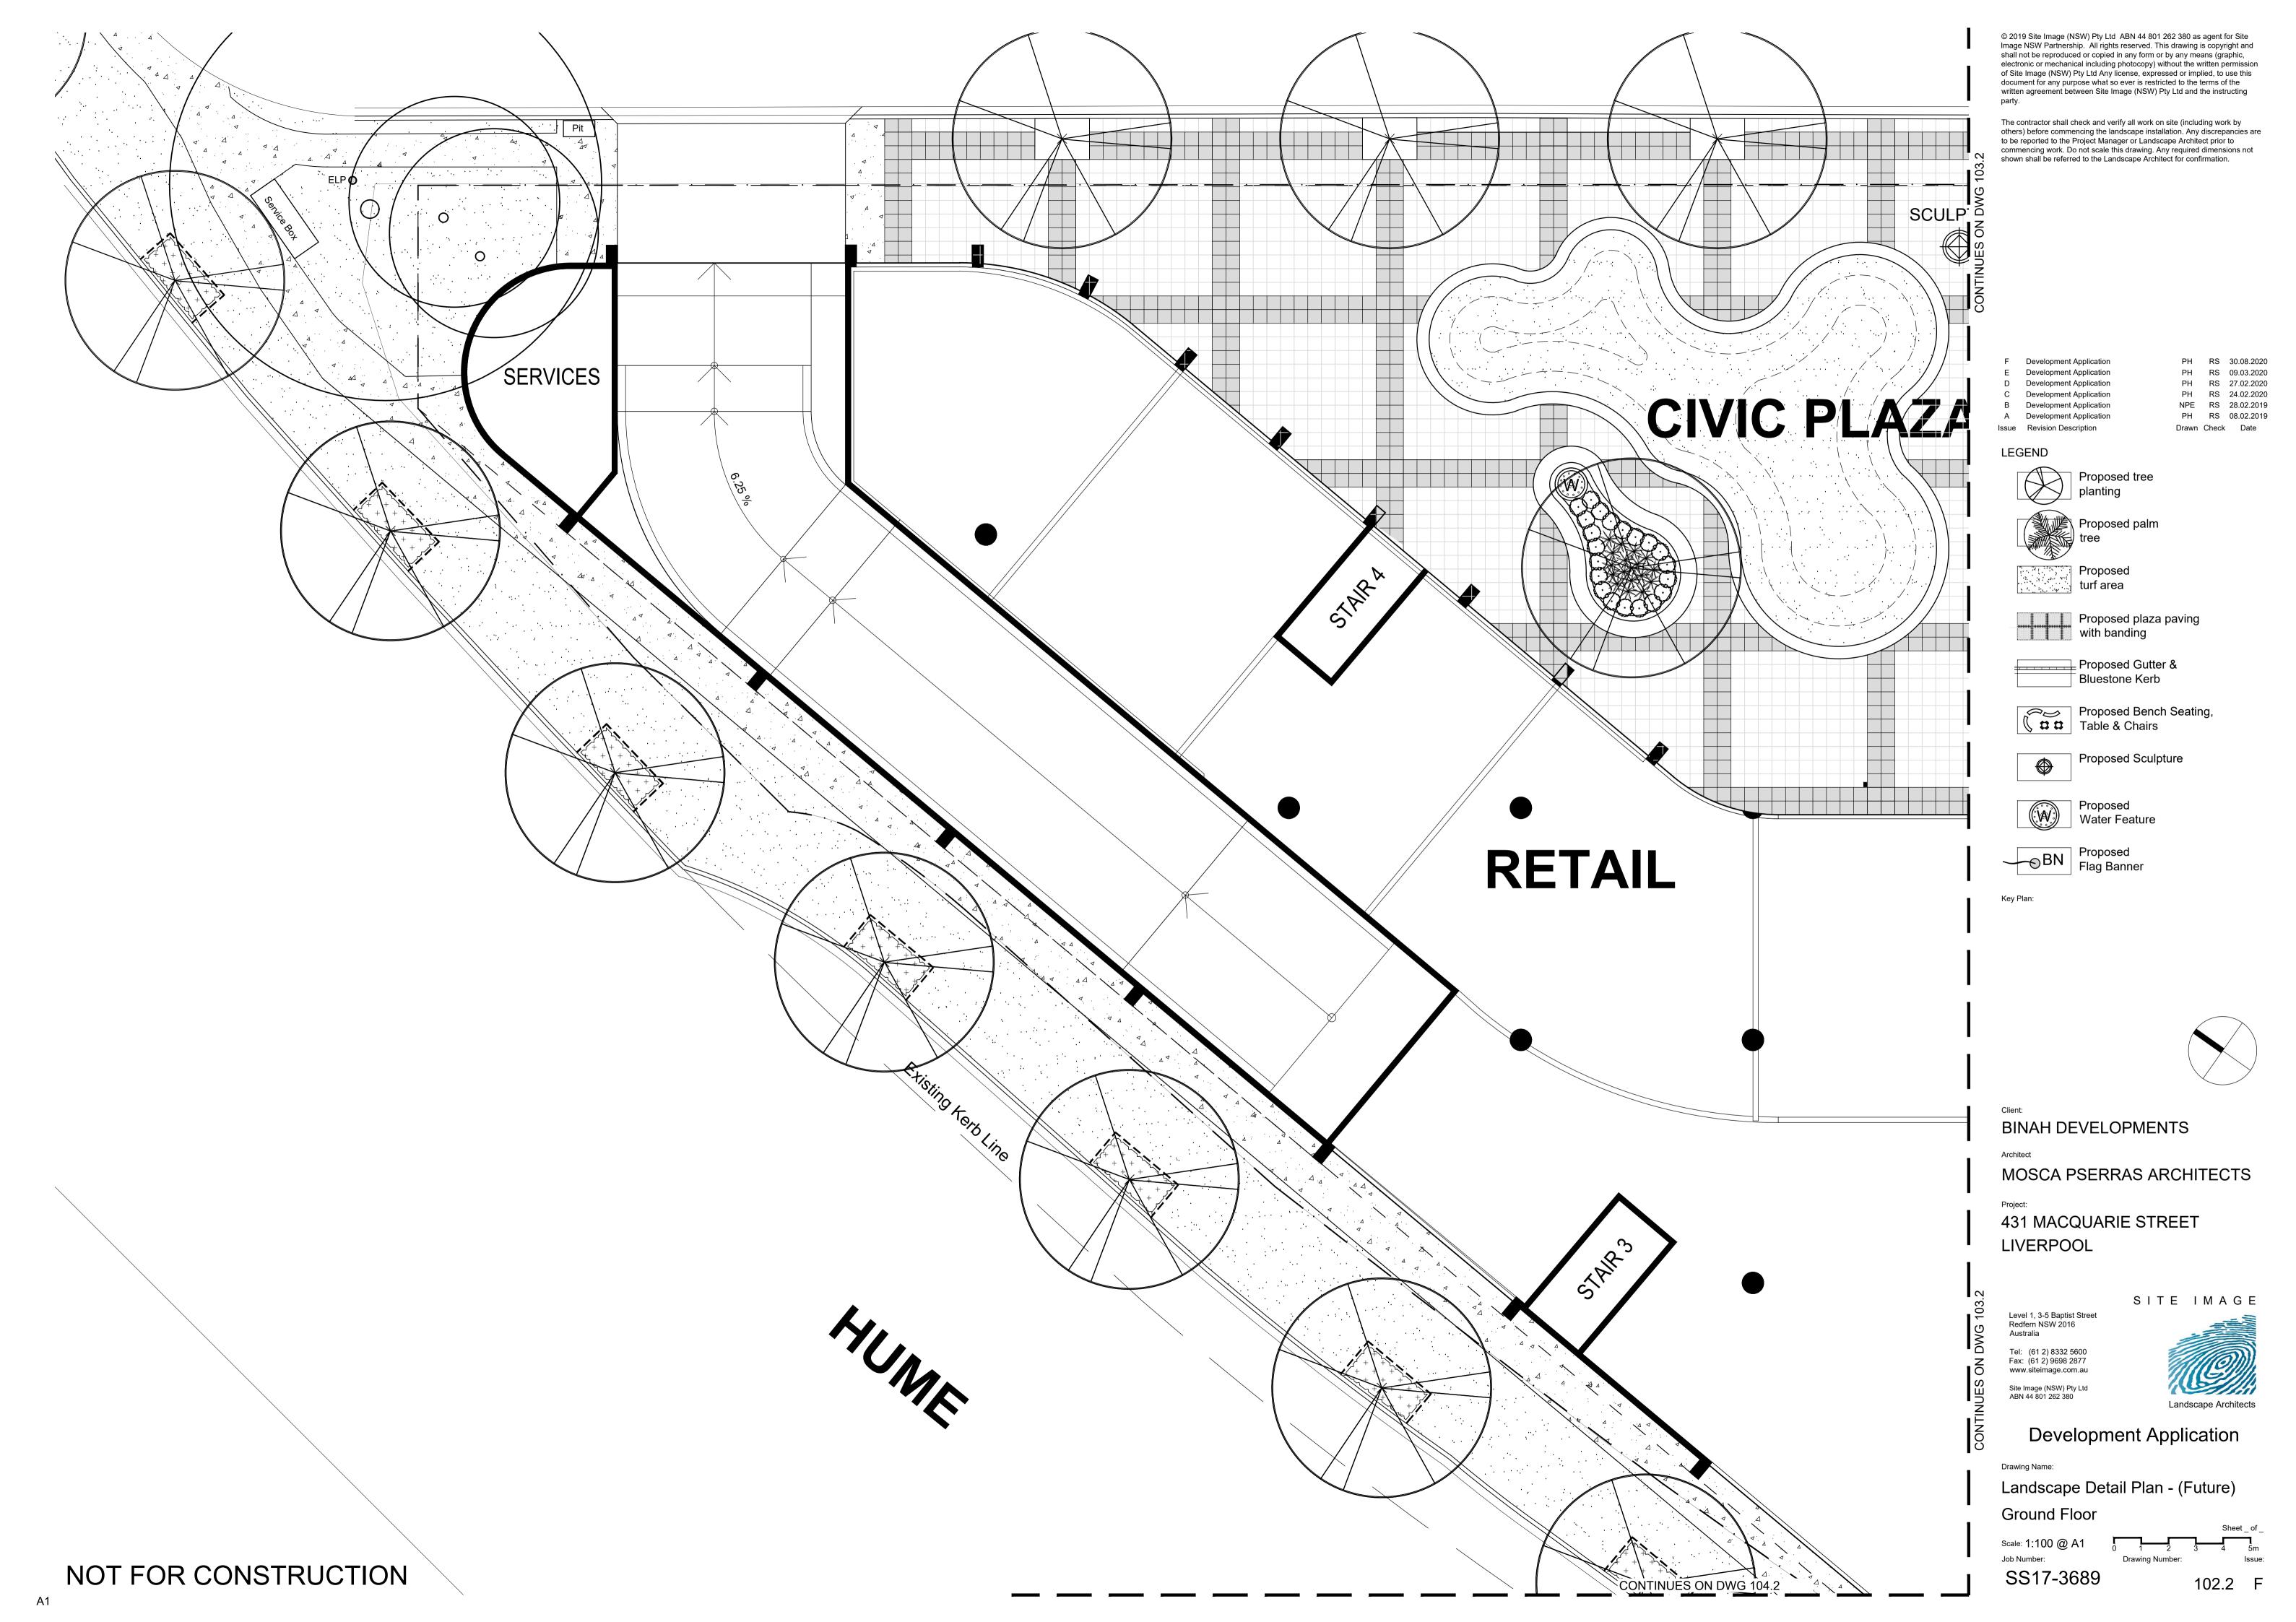



Development Application

Landscape Plan - (Future) **Ground Floor**

Scale: 1:200 @ A1
Job Number: SS17-3689

101.2 F



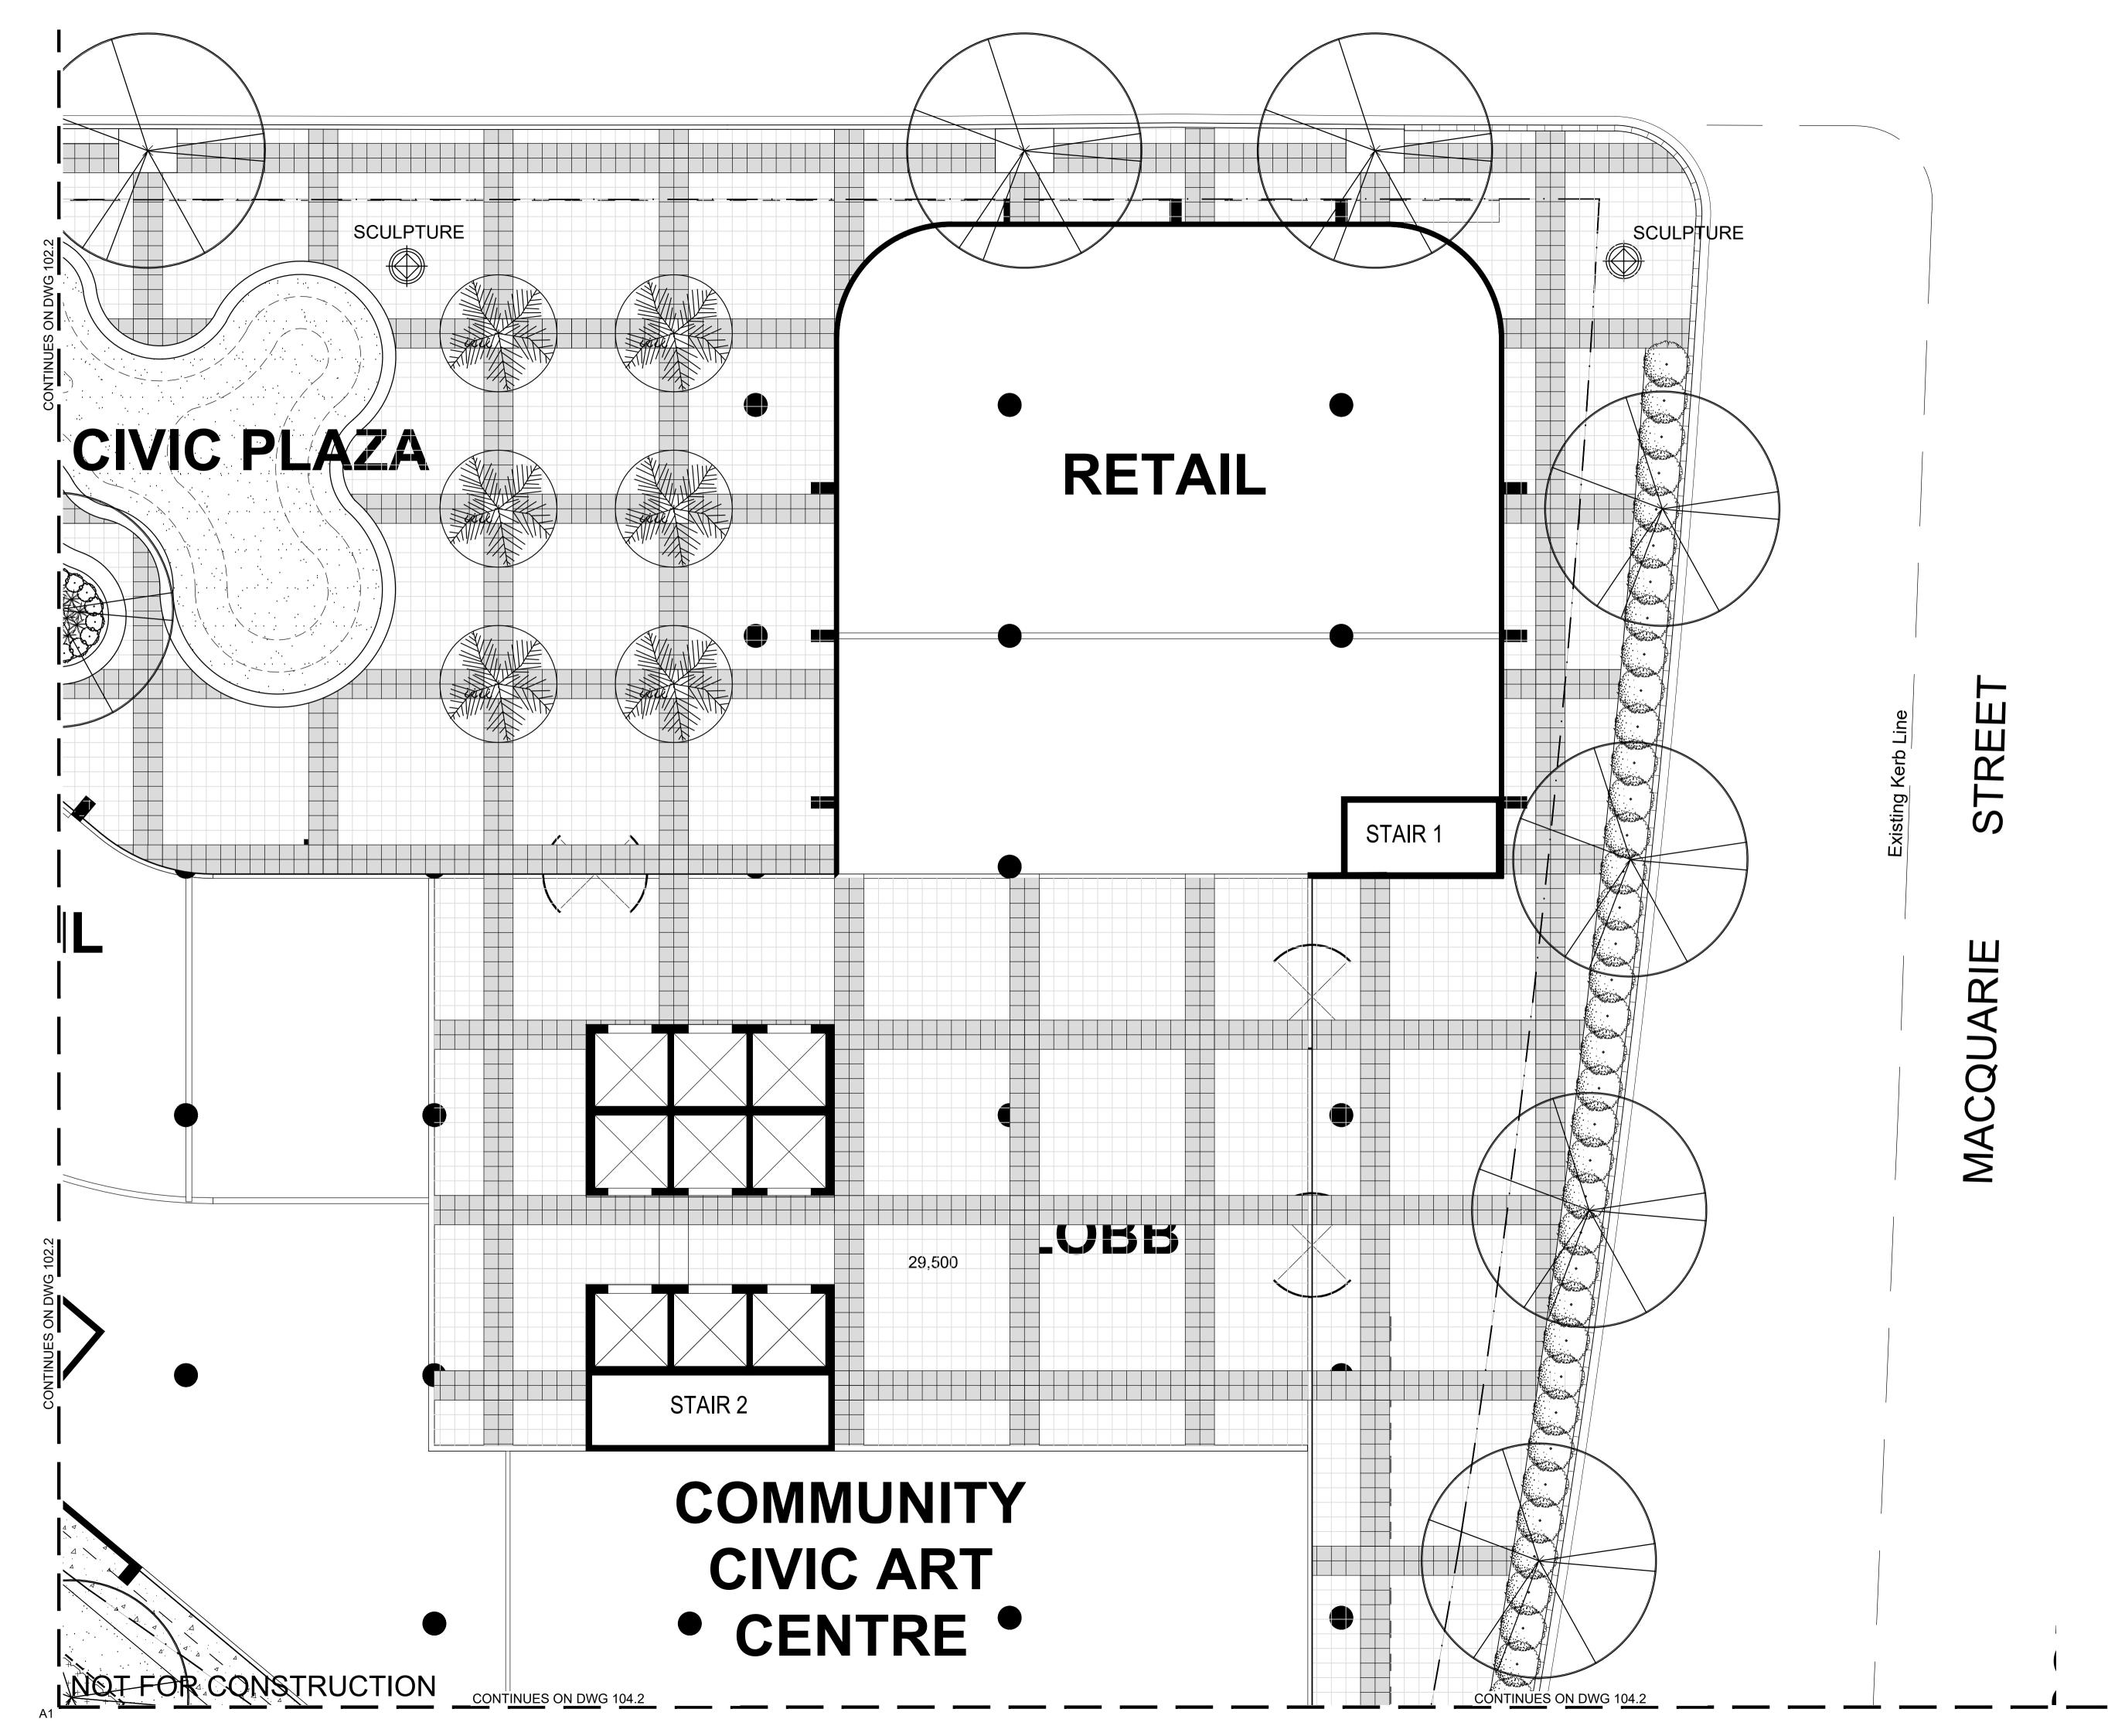

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Development Application NPE RS 28.02.2019 Development Application RS 08.02.2019 Drawn Check Date

LEGEND

Proposed tree

planting

↑ Proposed palm

turf area


Proposed plaza paving with banding Proposed Gutter &

Bluestone Kerb

Proposed Bench Seating,
Table & Chairs Proposed Sculpture

Proposed Water Feature

BN Proposed Flag Banner

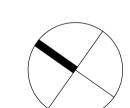

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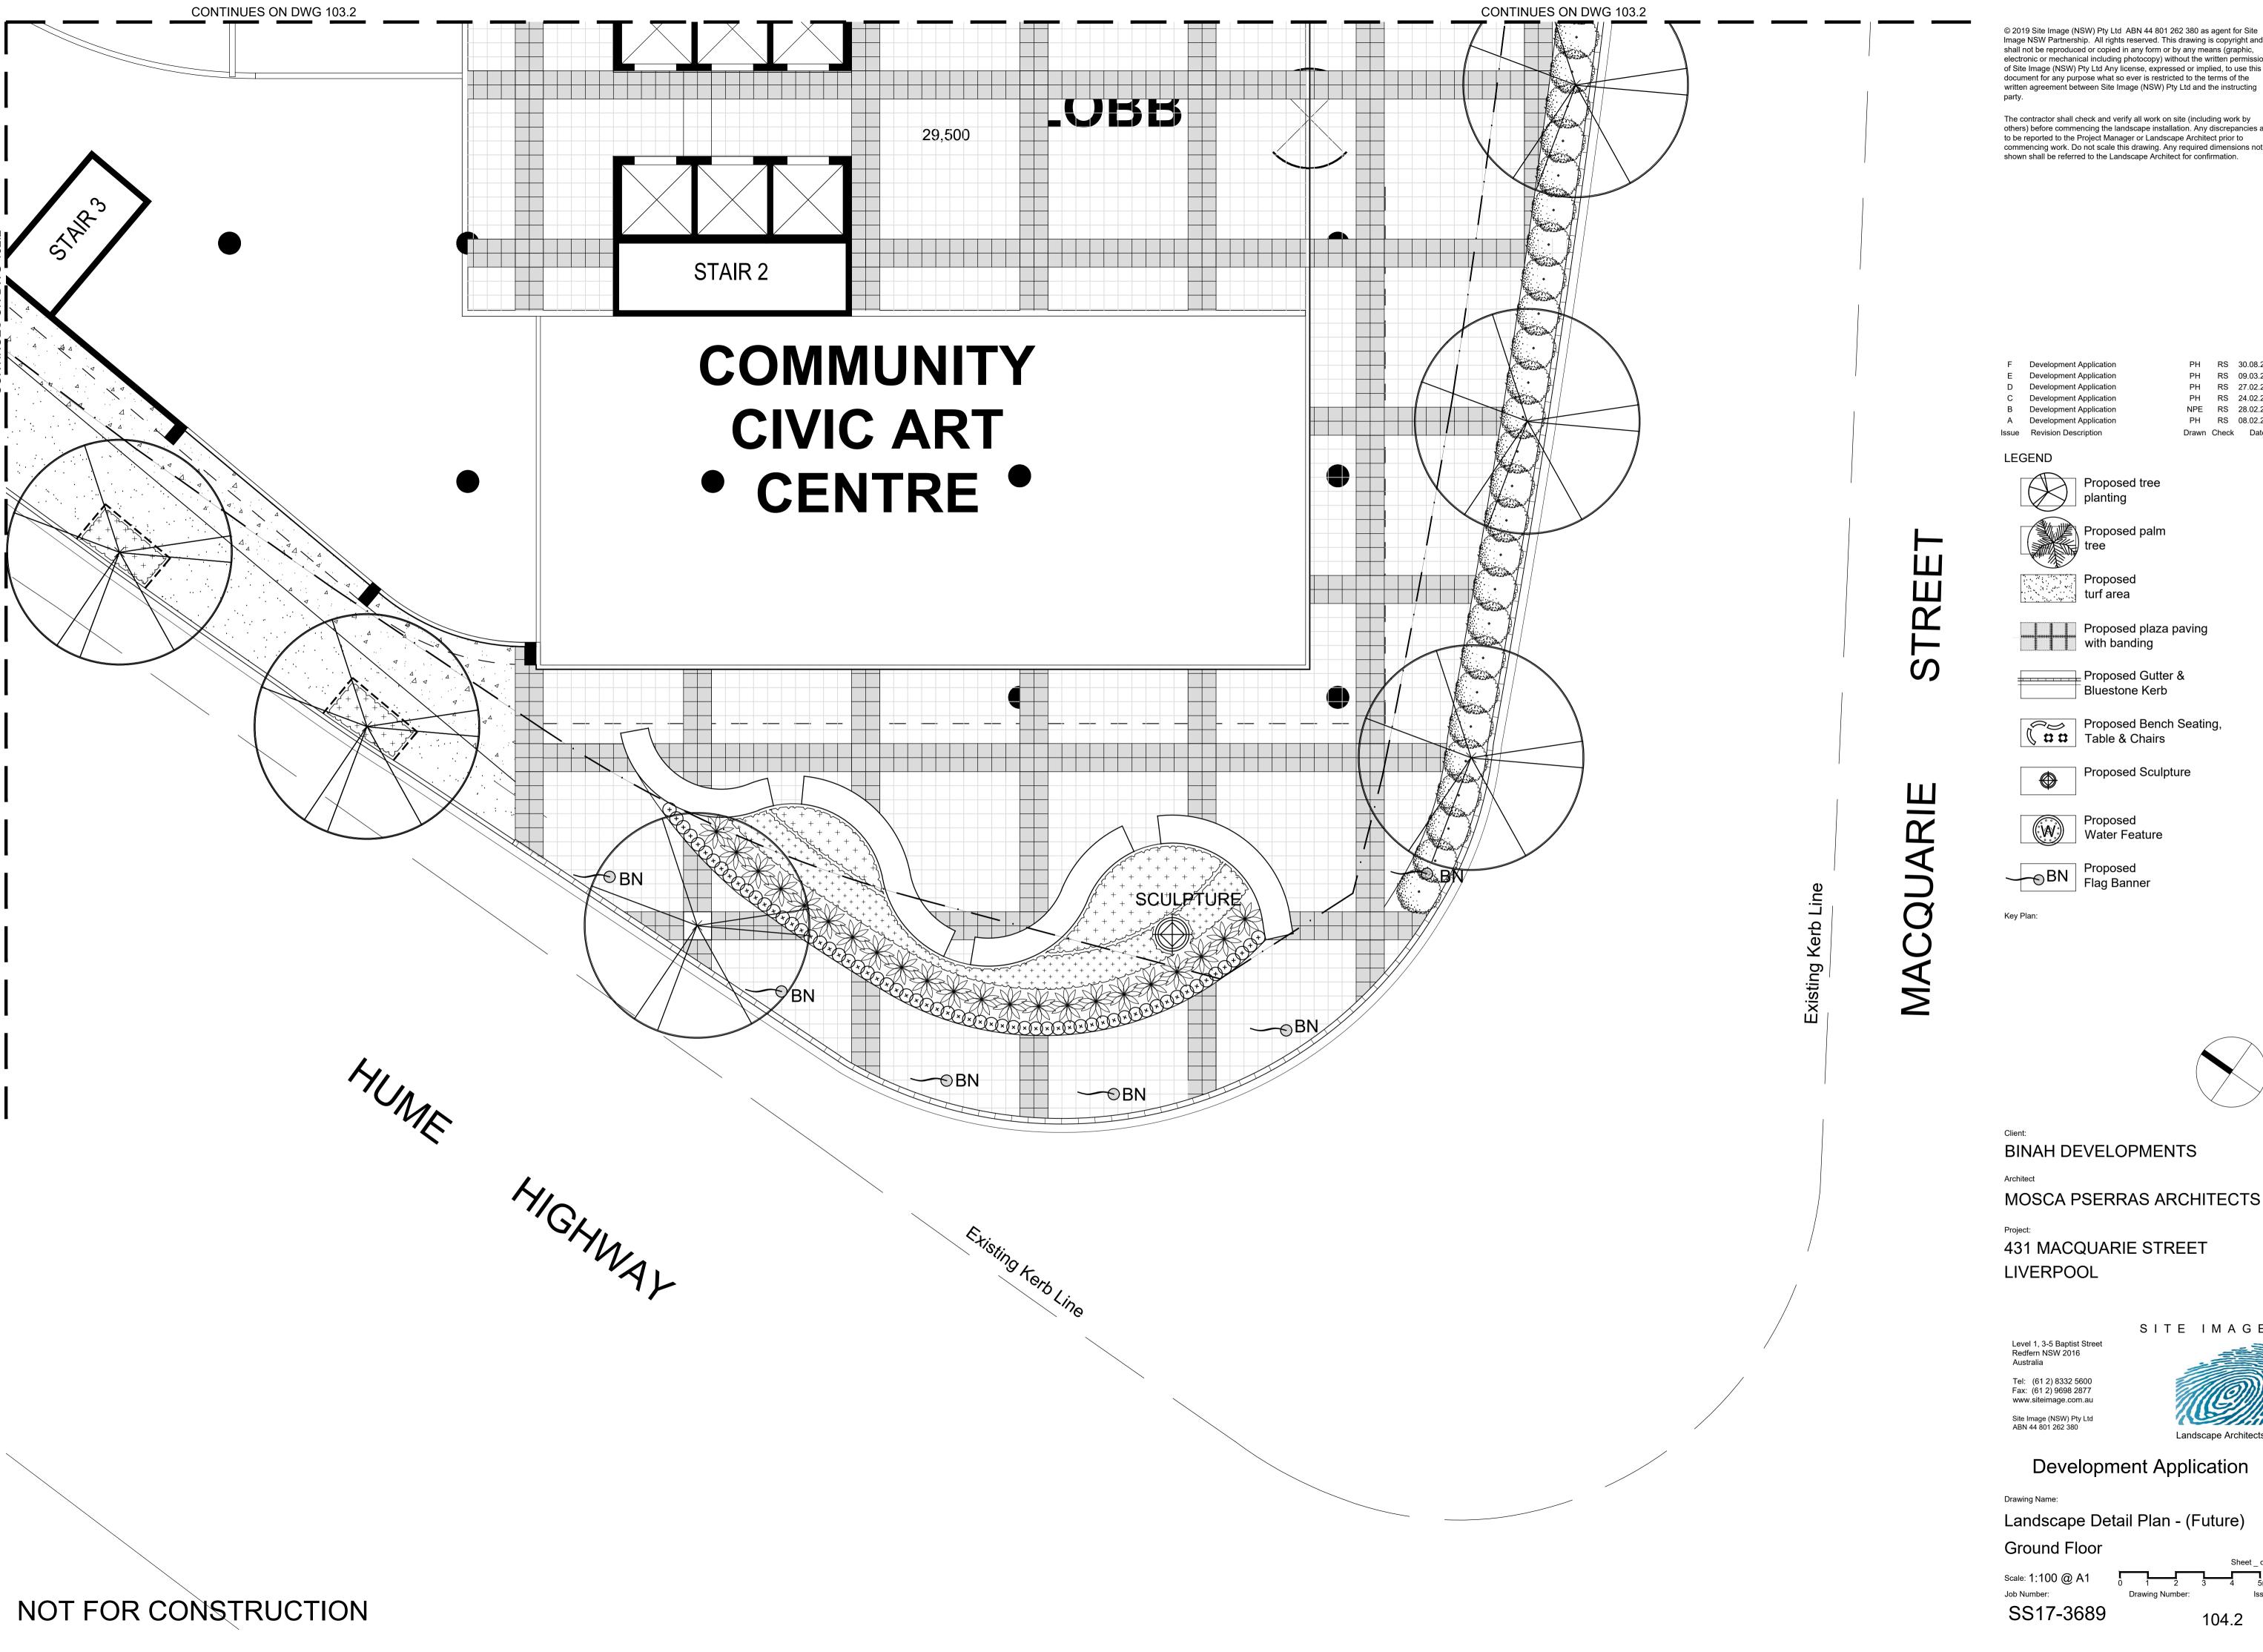
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Landscape Detail Plan - (Future) **Ground Floor**

Scale: 1:100 @ A1

SS17-3689

103.2 F



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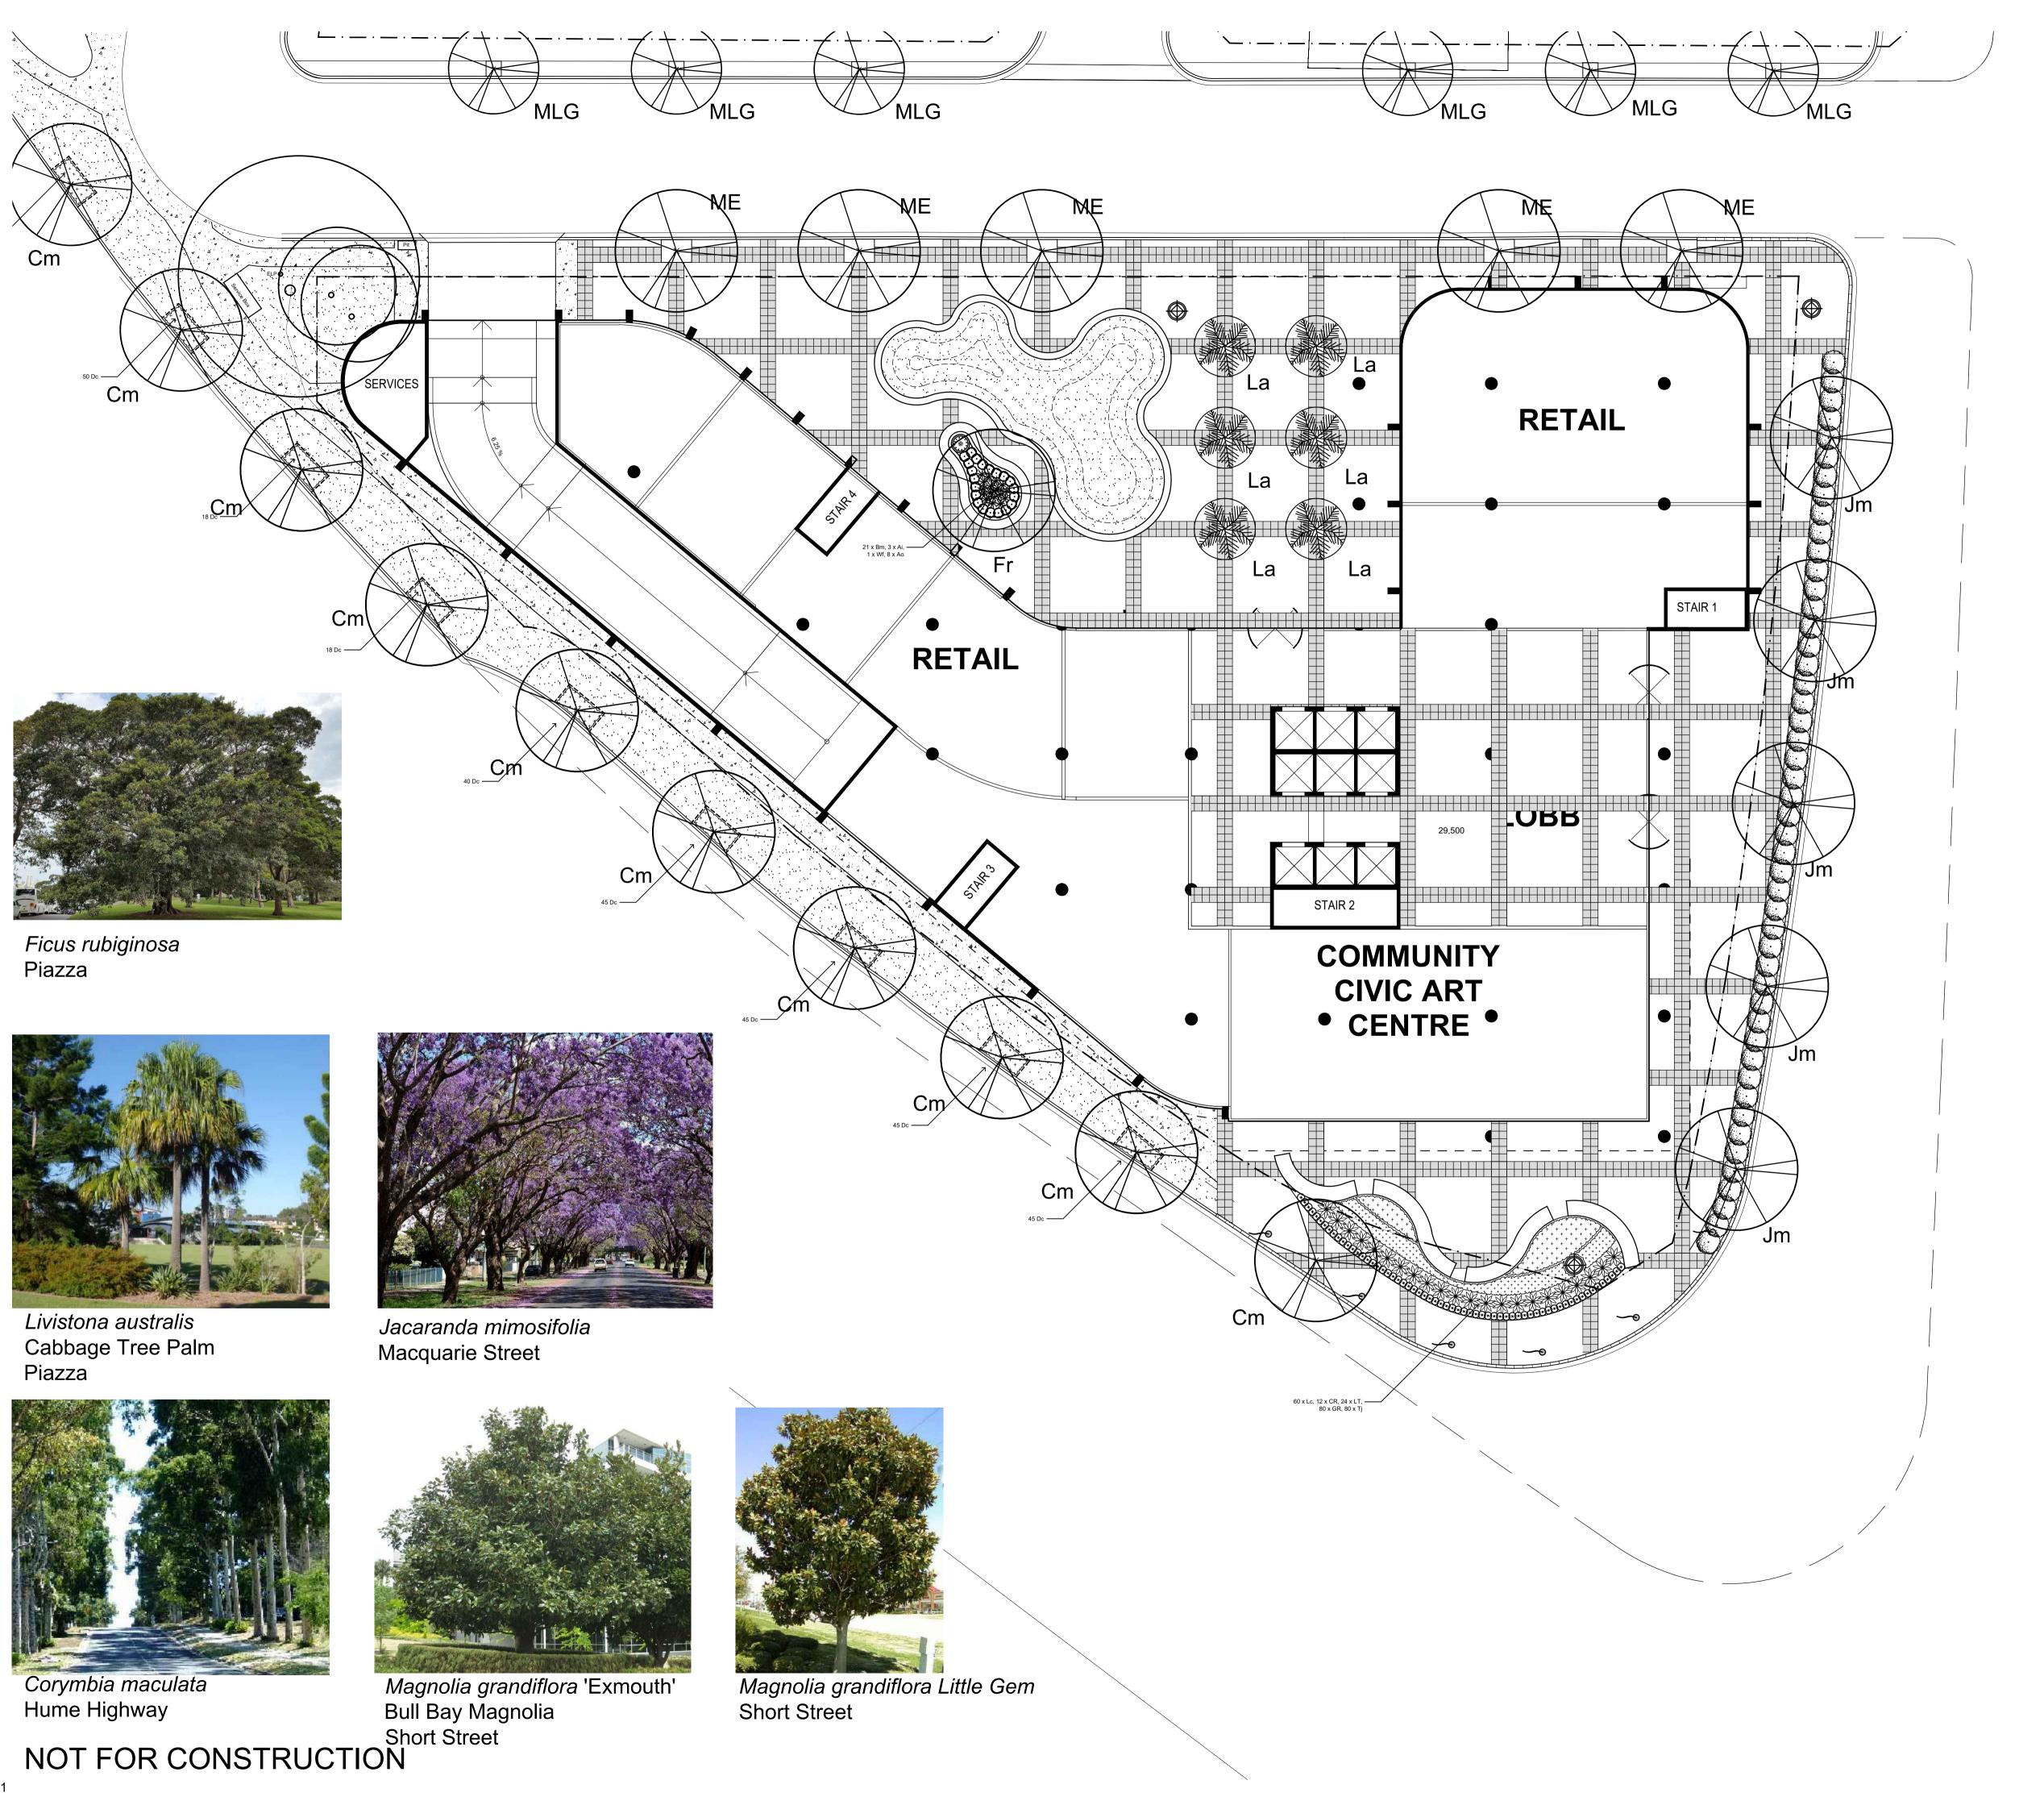
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Landscape Detail Plan - (Future)

104.2 F



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LEGEND

Issue Revision Description

Proposed tree planting

Proposed palm

turf area

Proposed plaza paving with banding


Proposed Gutter & Bluestone Kerb

Proposed Bench Seating, Table & Chairs

Proposed Sculpture

Proposed
Water Feature

BN Proposed Flag Banner

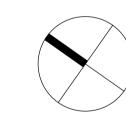

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Landscape Planting Plan

- Ground Floor

Scale: 1:200 @ A1 201.2 F

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